




Ministry of Public Works

P.O. Box HM51364 Hamilton HMFX Bermuda Phone: (441) 295-5151 Fax: (441) 295-5658

GENERAL NOTES:

- 4. DETAIL NEAR HORTICULTURAL HALL ADOPTED FROM 48320103 DWG.

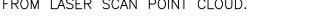



THIS PLAN MUST NOT BE ALTERED IN ANY WAY UNLESS AUTHORISED BY THE SENIOR LAND SURVEYOR ONLY AUTHENTICATED COPIES OF THIS PLAN SHOULD BE USED © COPYRIGHT - BERMUDA GOVERNMENT

ISSUED FOR:

AMENDMENTS:	

NO:	REVISION	APP	DATE:
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SCALE: 1"= 20' PREPARED BY: DESIGN PREPARED BY:

CHECKED BY: 04/07/24 DATE: 04/07/24 CHECKED BY:

APPROVED BY: S. PATTERSON - SENIOR LAND SURVEYOR

PROJECT NUMBER: 30/243/14 TASK 240028

PROJECT NAME:

EXOTIC AND CACTUS HOUSE

TOPO BOTANICAL GARDENS SOUTH ROAD

PAGET CIVIL 3D 2019 DRAWING FILE NO: PIMS\SURVEYPROJECTS\3024314\483201005

SHEET TITLE: TOPOGRAPHIC SURVEY

SHEET NUMBER: REVISION 4832/010/05



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DEPARTMENT OF WORKS AND ENGINEERING

Fax: (441) 295-5658



ENGINEERING SERVICES

ISSUED FOR: PERMIT

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DESIGN PREPARED BY: J. DILL DATE: 09/13/24 CHECKED BY:

DRAWING PREPARED BY: CHECKED BY:

APPROVED BY:

PROJECT NUMBER 09010030

PROJECT NAME:

CACTI HOUSE REDEVELOPMENT PROJECT 2024

SHEET TITLE:

PROJECT LOCATION

L-000

SHEET NUMBER: 0

APPROVED 07 Dec 2024

BUILDING CONTROL

[27]-[September]-[2024]
BERMUDA FIRE & RESCUE SERVICE By: Anthrun O'Brien Rank: A/Sgt Ref: 16/2



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ENGINEERING SERVICES

Phares (44) 29+368) Emuli Wolfepelen

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APPROVED BY:	DATE:

09010030 PROJECT NAME:

CACTI HOUSE REDEVELOPMENT PROJECT 2024

SHEET TITLE:

PROJECT AREA OF WORK

0

١	SHEET NUMBER:
١	L-001

APPROVED
07 Dec 2024

BUILDING CONTROL

ALL BUILDING WORKS AND MATERIALS SHALL CONFORM TO
THE REQUIREMENTS OF THE BUILDING ACT 1988, THE
BERMUDA BUILDING GODE 2014 AND ALL OTHER CODES AND
STANDARDS IN FORCE ALL WORKS SHALL BE INSPECTED
AND APPROVED PRIOR TO CONCEALMENT.

GENERAL NOTES:

- 1. ALL DRAWINGS SHALL BE READ IN CONJUNCTION WITH THE SPECIFICATION AND ANY OTHER WRITTEN INSTRUCTIONS ISSUED.
- INSTRUCTIONS ISSUED.
 2. WHERE APPROVAL IS REQUIRED. THIS SHALL BE OF THE DESIGNING ENGINEER AND/OR
- REPRESENTATIVE.

 3. ANY AMBIGUITY OR DISCREPANCY SHALL BE REFERRED FOR CLARIFICATION AT THE TENDERING STAGE AND APPROVAL GAINED FROM THE DESIGNING ENGINEER/REPRESENTATIVE.
- 2. DIMENSIONS ARE IN PRESENTED MILLIMETERS WITH EQUIVALENT FOOT/INCH VALUE SHOWN IN BRACKETS.

EXAMPLE: 1000mm [3'-3 \frac{3}{8}"]

- 3. REFER TO THE DRAWING DIMENSIONS FOR SETTING OUT THE WORKS. HOWEVER, ALL EXISTING DIMENSIONS AND LEVELS ARE APPROXIMATE AND SHALL BE CONFIRMED BY THE CONTRACTOR ON SITE.
- 4. UNLESS NOTED OTHERWISE, ALL LEVELS ARE IN METRES [m]
- 5. THE CONTRACTOR SHALL BE RESPONSIBLE FOR MAINTAINING THE STABILITY OF THE STRUCTURE UNTIL ITS COMPLETION AND SHALL ENSURE THAT NO PART OF THE STRUCTURE IS OVERSTRESSED DURING THE WORKS.
- 6. WHERE STANDARDS ARE REFERRED TO, THEY SHALL BE THE LATEST EDITION.
- 7. PROPRIETARY ITEMS, PROPOSED BY THE CONTRACTOR, ARE TO BE APPROVED EQUALS, REVIEWED AND APPROVED BY THE DESIGNING ENGINEER PRIOR AND INCLUDED WITHIN SUBMITTED TENDERS.
- 8. THE CONTRACTOR SHALL BE RESPONSIBLE FOR SECURING WORK AREAS
 - ALL DEMOLITION SHALL BE IN AN ACCEPTABLE MANNER UNDER THE OCCUPATIONAL HEALTH AND SAFETY REGULATIONS 2009. ALL SURPLUS MATERIAL SHALL BE DISPOSED OF OFF SITE IN A LEGAL MANNER.

SITE PROTECTION NOTES

- 1. THE CONTRACTOR SHALL INSTALL SITE PROTECTION AS APPROVED BY THE PROJECT MANAGER PRIOR TO THE START OF CLEARING. DEMOLITION. GRADING OR OTHER CONSTRUCTION WORK.
- 2. THE CONTRACTOR SHALL VERIFY LOCATION OF ALL BURIED SERVICES WITH THE RELEVANT AUTHORITIES BEFORE UNDERTAKING EXCAVATION WORK ON SITE. ALL EXISTING PLANTS, SERVICES AND WALKWAY FINISHES ARE TO REMAIN UNLESS NOTED OTHERWISE.
- 3. THE CONTRACTOR SHALL PROTECT ALL EXISTING TREES, PLANTS AND PLANTING BED SURFACES FROM CONSTRUCTION ACTIVITY. THIS INCLUDES PROTECTION FROM DAMAGE CAUSED BY RUNOFF OR SPILLAGE OF CONSTRUCTION MATERIALS AND OR FROM ADJACENT CONSTRUCTION ACTIVITIES.
- 4. ALL DEMOLITION AND EXCAVATION WITHIN TREE DRIP LINES AND SITE PROTECTION AREAS SHALL BE ACCOMPLISHED BY HAND OR AIR EXCAVATION TOOLS.
- THE CONTRACTOR SHALL PROTECT TREE AND PLANT ROOT SYSTEMS FROM DAMAGE CAUSED BY RUNOFF OR SPILLAGE OF CONSTRUCTION MATERIALS AS WELL AS FROM CONSTRUCTION ACTIVITIES.
- 6. THE CONTRACTOR SHALL PROTECT TREE AND PLANT ROOT SYSTEMS FROM FLOODING, ERODING, OR EXCESSIVE
- WETTING CAUSED BY CONSTRUCTION ACTIVITIES.

 7. THE CONTRACTOR SHALL NOT DISTURB, OPERATE VEHICLES OR EQUIPMENT, STORE MATERIALS, OR PERMIT FOOT
- TRAFFIC WITHIN TREE PROTECTION AND PLANT BED AREAS.
- THE CONTRACTOR SHALL KEEP PLANT BEDS AND TREE PROTECTION AREAS FREE FROM LITTER AND DEBRIS.
 THE CONTRACTOR SHALL FIELD VERIFY ALL POST LOCATIONS AND PROMPTLY NOTIFY THE PROJECT MANAGER OF ANY DISCREPANCIES OF CONSTRUCTION CONFLICTS WITH EXISTING PLANTS PROTECTION AREAS.
- DISCREPANCIES OR CONSTRUCTION CONFLICTS WITH EXISTING PLANTS, ROOT SYSTEMS OR PLANT PROTECTION AREAS PRIOR TO START OF CONSTRUCTION WORK. OBTAIN WRITTEN INSTRUCTION FROM THE PROJECT MANAGER PRIOR TO PROCEEDING WITH ANY CONSTRUCTION ACTIVITY WITHIN PLANT PROTECTION AREAS.
- 10. THE CONTRACTOR SHALL PROTECT EXISTING GRASSES, SOILS AND EARTHWORK FROM DAMAGE CAUSED BY COMPACTION, SETTLEMENT, LATERAL MOVEMENT, UNDERMINING, EROSION, WASH OUT AND OTHER HAZARDS CREATED BY CONSTRUCTION ACTIVITY.

SITE / PLANT DAMAGE & REPAIR NOTES:

- 1. SHOULD EXISTING PLANTS BE DAMAGED DURING THE CONTRACT, THE CONTRACTOR WILL BE ASKED TO ARRANGE TO PRUNE, REPAIR OR REPLACE AS NECESSARY THOSE AFFECTED BY INADVERTENT ROOT LOSS OR DAMAGE.
- 2. THE CONTRACTOR SHALL ARRANGE TO REPAIR PLANTS DAMAGED BY CONSTRUCTION OPERATIONS WITHIN 24 HOURS AS DIRECTED BY THE PROJECT MANAGER.
- 3. THE CONTRACTOR SHALL REPLACE PLANTS DAMAGED BEYOND REPAIR AS DETERMINED BY THE PROJECT MANAGER WITH APPROVED EQUAL OR BETTER MATERIAL.
- 4. THE CONTRACTOR SHALL REINSTATE ALL GRASS AREAS DAMAGED BY CONSTRUCTION ACTIVITY AND VEHICLES AS DIRECTED BY THE PROJECT MANAGER.

CONCRETE NOTES:

- 1. CONCRETE SHALL COMPLY WITH THE FOLLOWING SPECIFICATION:
- MINIMUM CONCRETE STRENGTH AT SERVICE F'c = 25 MPa [3600PSI]
- MINIMUM CEMENT CONTENT = $440 \text{ Kg/m}^3 [28 \text{ lb/ft}^3]$
- MAXIMUM WATER/CEMENT RATIO = 0.5
- 2. CONCRETE MIX DESIGNS TO BE SUBMITTED TO THE ENGINEER FOR APPROVAL
- 3. NO ADDITIVES TO BE USED WITHOUT THE PRIOR APPROVAL OF THE ENGINEER.
- 4. CAST IN ITEMS WITH LESS THAN 25mm COVER TO ATMOSPHERE SHALL BE HOT DIPPED GALVANISED IN ACCORDANCE WITH ASTM A153.
- 5. ALL FORMWORK, SHORING AND RESHORING SHALL BE THE RESPONSIBILITY OF AND DESIGNED BY THE CONTRACTOR
- 4. CONCRETE SHALL BE TESTED FOR SLUMP ON SITE. THE TEST CYLINDERS SHALL BE TAKEN FOR 3, 7 AND 28 DAY STRENGTHS.
- 5. CONCRETE STRENGTH AND SLUMP TO BE AS FOLLOWS

MIN. SPECIFIED 28 DAY STRENGTH	SLUMP
25 MPa	75mm ± 25mm
[3600PSI]	[3" ± 1"]

TIMBER NOTES:

- 1. THE TIMBER STRUCTURE HAS BEEN DESIGNED WITH PINE WOOD TO A MINIMUM GRADE No. 2. THE CONTRACTOR IS TO SUPPLY AND INSTALL SPECIFIED TIMBER
- 2. IF SPECIFIED TIMBER IS NOT AVAILABLE OR AN ALTERNATIVE WOOD IS PREFERRED, THE DESIGNING ENGINEER IS TO BE CONSULTED PRIOR TO PURCHASING, SUPPLY AND INSTALLATION.
- 3. 14 GAUGE WOOD SCREWS (6.2mm DIAMETER) ARE TO BE USED THROUGHOUT FOR WOOD ON WOOD CONNECTIONS.
- 4. TIMBER IS TO BE TREATED AND PROTECTED FOR OUTDOORS CONDITIONS.
- 5. PARKS DEPARTMENT TO BE CONSULTED ON CHOSEN PAINTING SPECIFICATIONS

DESIGN NOTES:

1. THE DESIGN OF THE TIMBER STRUCTURE AS SHOWN IN THIS PACKAGE OF DRAWINGS IS BASED ON THE FOLLOWING PARAMETERS:

LOADING

PERMANENT ROOF LOADING = 0.1 kN/m² (2.1 lbs/ft²)

SERVICE LOADING * = 0.25 kN/m² (5.2 lbs/ft²)

(*HANGING SERVICES SUCH AS CABLING AND MECHANICAL EQUIPMENT)

LIVE LOADING = $0.6 \text{ kN/m}^2 (12.5 \text{ lbs/ft}^2)$


ROOFING NOTES:

1. ROOF PANELING HAS BEEN DESIGNED AS PHASE-2 PVC CORRUGATED ROOF PANELS 4.2" x 1-1/16" CONFIGURATION (16 Oz./ft²). IF ALTERNATIVE ROOF CLADDING IS TO BE USED, CORRESPONDING TECHNICAL SPECIFICATIONS ARE TO BE SENT TO MPW ENGINEER FOR REVIEW DURING THE TENDERING PERIOD.

- 2. THE ROOF STRUCTURE HAS BEEN DESIGNED TO ALLOW HUMAN ACCESS FOR MAINTENANCE AND CLEANING. ADEQUATE AT-HEIGHT-PROTECTION TO BE EMPLOYED BY PERSONNEL WORKING ON THE ROOF.
- UPPER HUT VERTICALS TO BE COVERED IN MESH TO MEET THE FOLLOWING SPECIFICATIONS:
- 3.1. MESH DURABILITY: MARINE-GRADE (E.G. COATED, GALVANIZED OR PVC)
- 3.2. MESH SIZE: SIZED TO PREVENT ACCESS BY SMALL BIRDS LIKE SPARROWS
 3.3. MESH OPENING SHAPE: DIAMOND, SQUARE OR RECTANGULAR SHAPES PERMITTED
- 3.4. MESH COLOR: PROVIDE COLOR OPTIONS FOR CLIENT REVIEW AND SELECTION.

ISOMETRIC VIEW OF NEW CACTI HOUSE 1/4" = 1'-0"



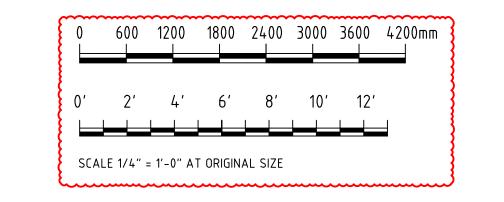

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DEPARTMENT OF WORKS AND ENGINEERING

Fax: (441) 295-5658



Maria

ISSUED FOR: BUILDING PERMIT APPLICATION

AMENDMENTS:

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NO	REVISION	BY	APP	DATE
Α	FOR TENDER	CF	-	14/06/24
В	REVISED FOLLOWING DESIGN TEAM COMMENTS	CF	-	04/07/24
С	REVISED FOLLOWING DESIGN TEAM COMMENTS	CF	1	11/07/24
D	ISSUED FOR BUILDING PERMIT APPLICATION	CF	1	12/07/24
Е	SCALES CHANGED AT REQUEST OF QS	CF	1	12/08/24

SCALE: AS SHOWN AT ANSI D

SURVEY
PREPARED BY:
DESIGN
PREPARED BY:
C.FRASER
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APPROVED BY:
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PROJECT NUMBER:

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DRAWING

C.FRASER

PREPARED BY:


BOTANICAL GARDENS CACTI HOUSE REFURBISHMENTS

2024

SHEET TITLE:

GENERAL NOTES
PROPOSED DESIGN


SHEET NUMBER: REVISION E

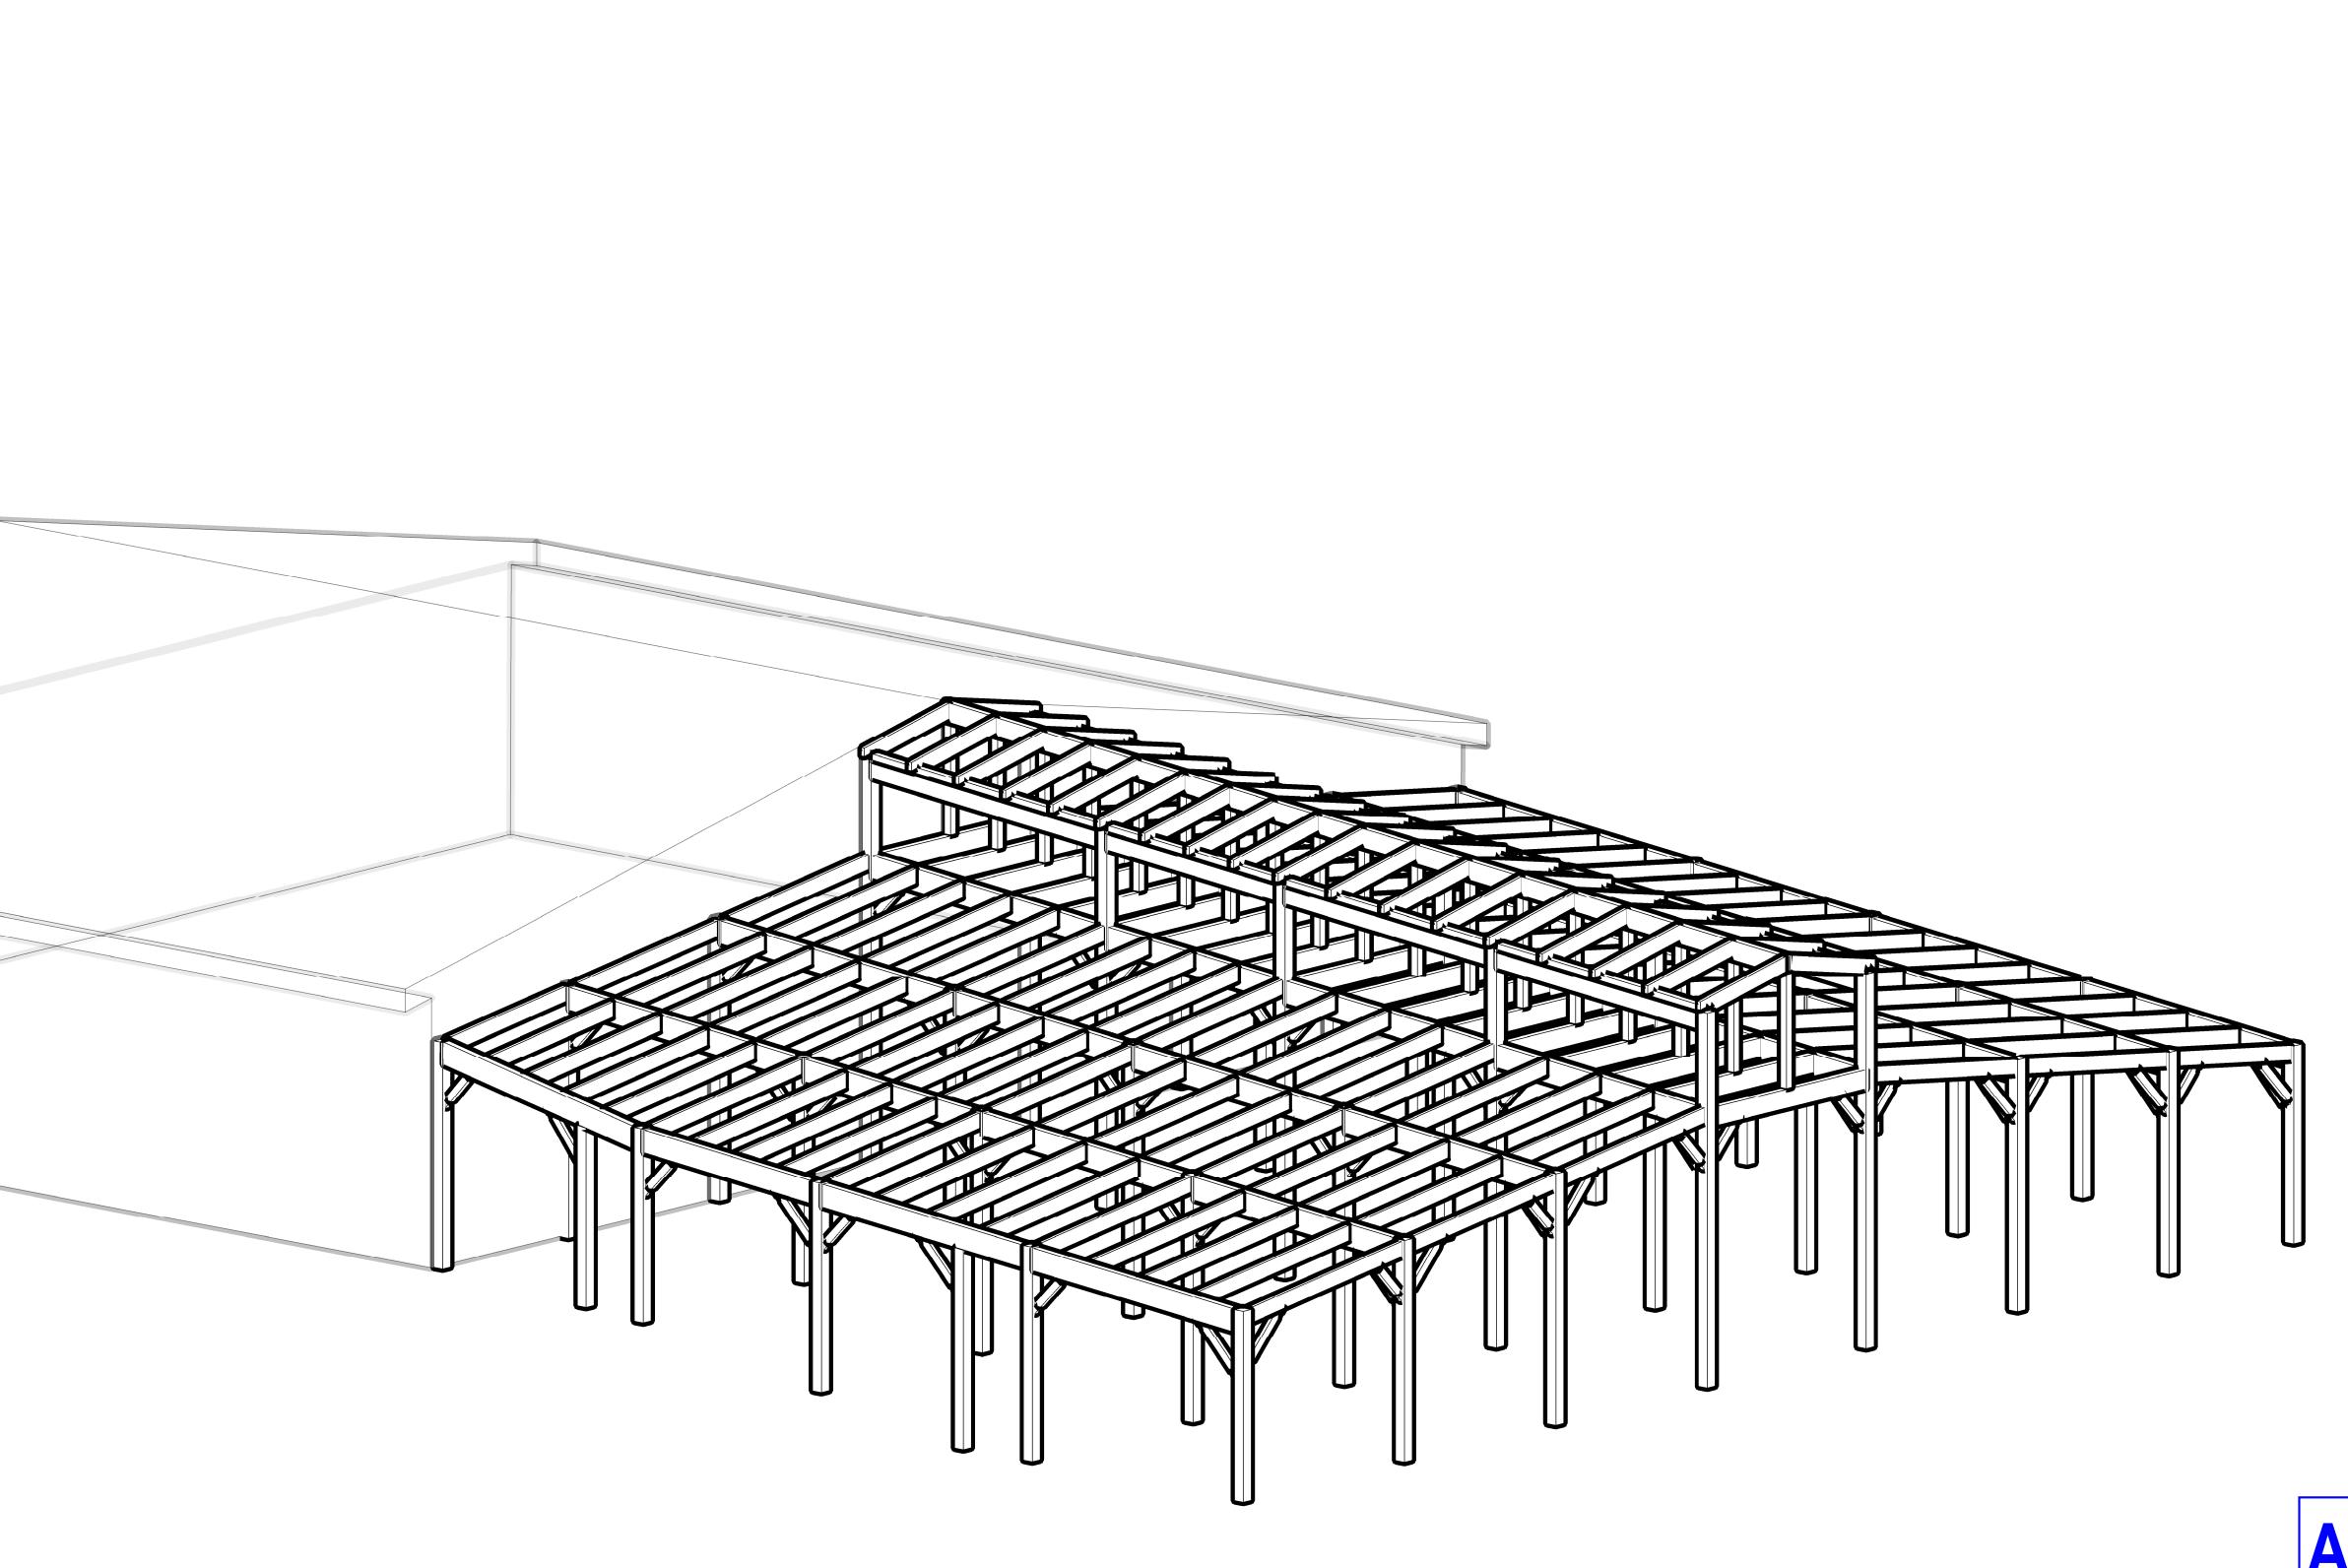

APPROVED 07 Dec 2024

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		D	SCALES CHANGED AT REQUEST OF QS	CF		12/08/24
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SURVEY PREPARED BY: DATE: DESIGN DATE: 14/06/24 PREPARED BY: C.FRASER DATE: CHECKED BY: DRAWING DATE: 14/06/24 PREPARED BY: C.FRASER

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PROJECT NAME:

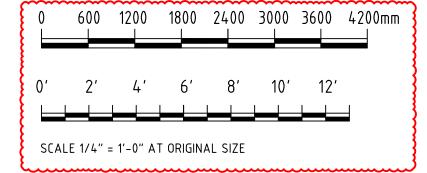BOTANICAL GARDENS CACTI HOUSE REFURBISHMENTS


2024

SHEET TITLE:

3D VIEW PROPOSED DESIGN

SHEET NUMBER: REVISION S001


ISOMETRIC VIEW OF NEW CACTI HOUSE
TIMBER STRUCTURE ONLY ROOF PANELS, PURLINS AND SIDE FENCING HIDDEN FOR CLARITY 1/4" = 1'-0"

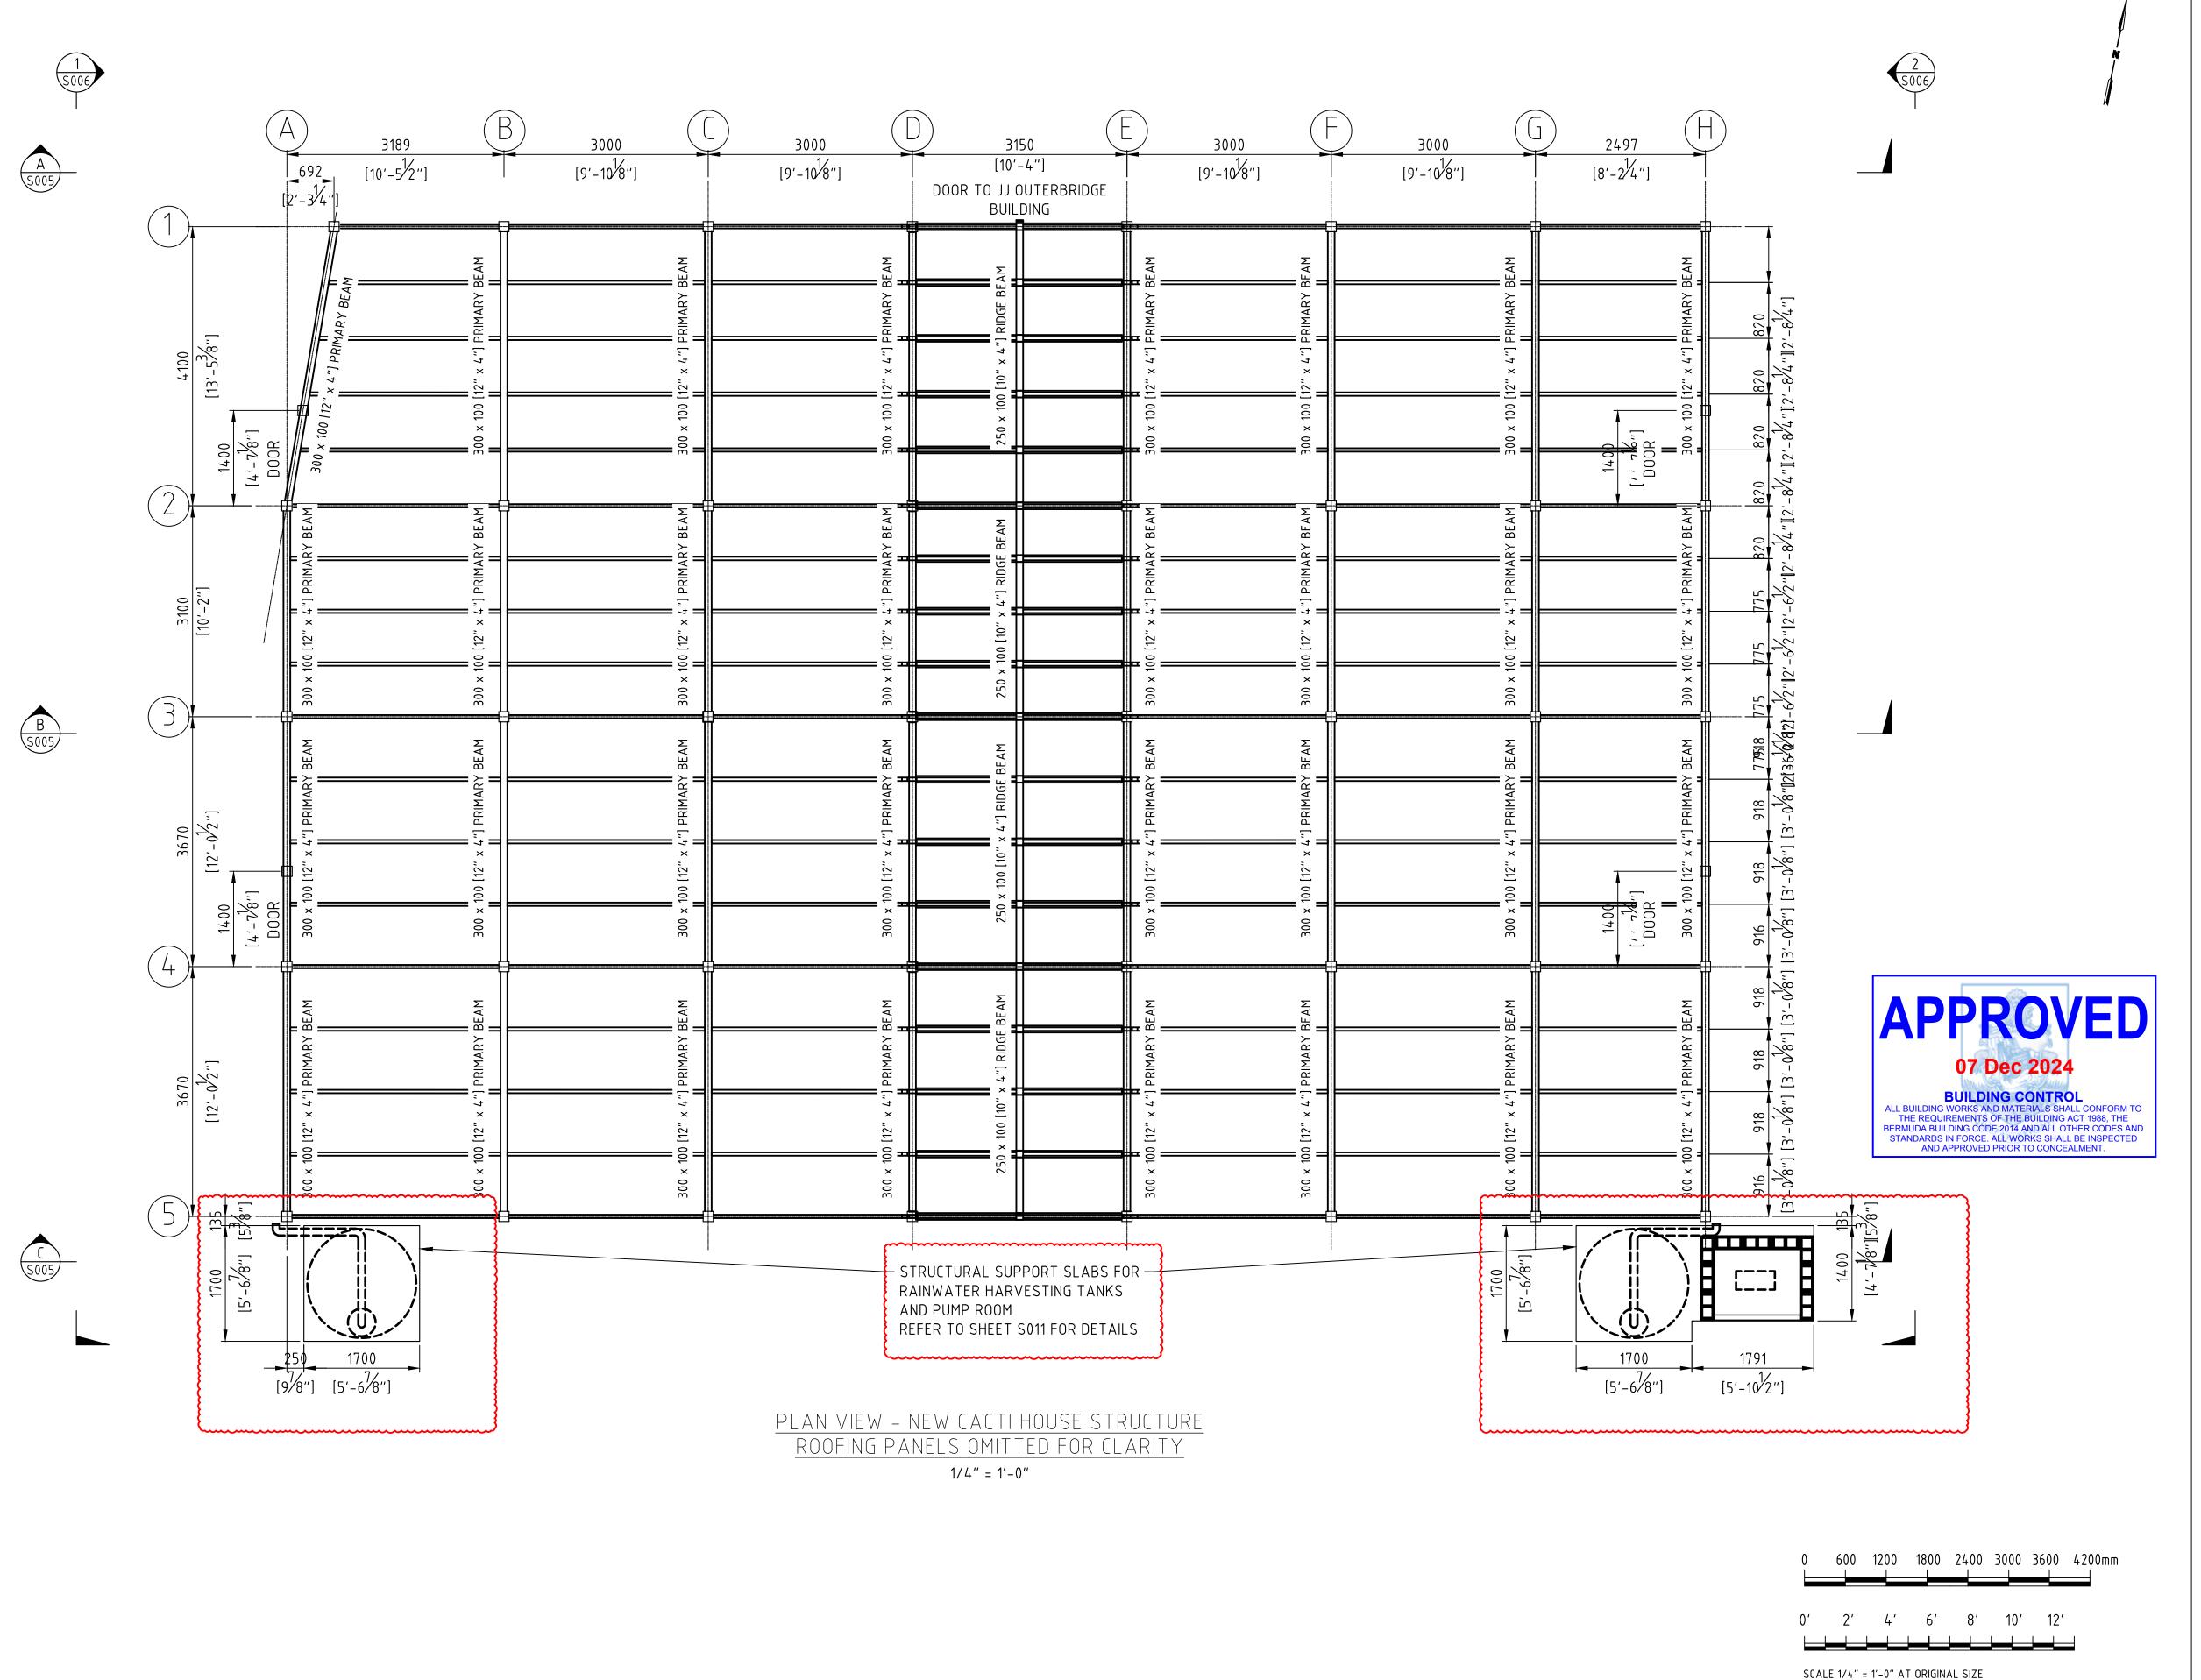

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AMENDMENTS:

NO	REVISION	BY	APP	DATE
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С	ISSUED FOR BUILDING PERMIT APPLICATION	CF	1	12/07/2
D	SCALES CHANGED AT REQUEST OF QS	CF	1	12/08/2
Е	TANK SLABS ADDED	CF	-	30/08/2

SCALE: AS SHOWN AT ANSI D
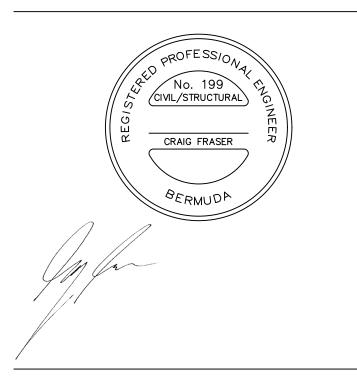
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C.FRASER

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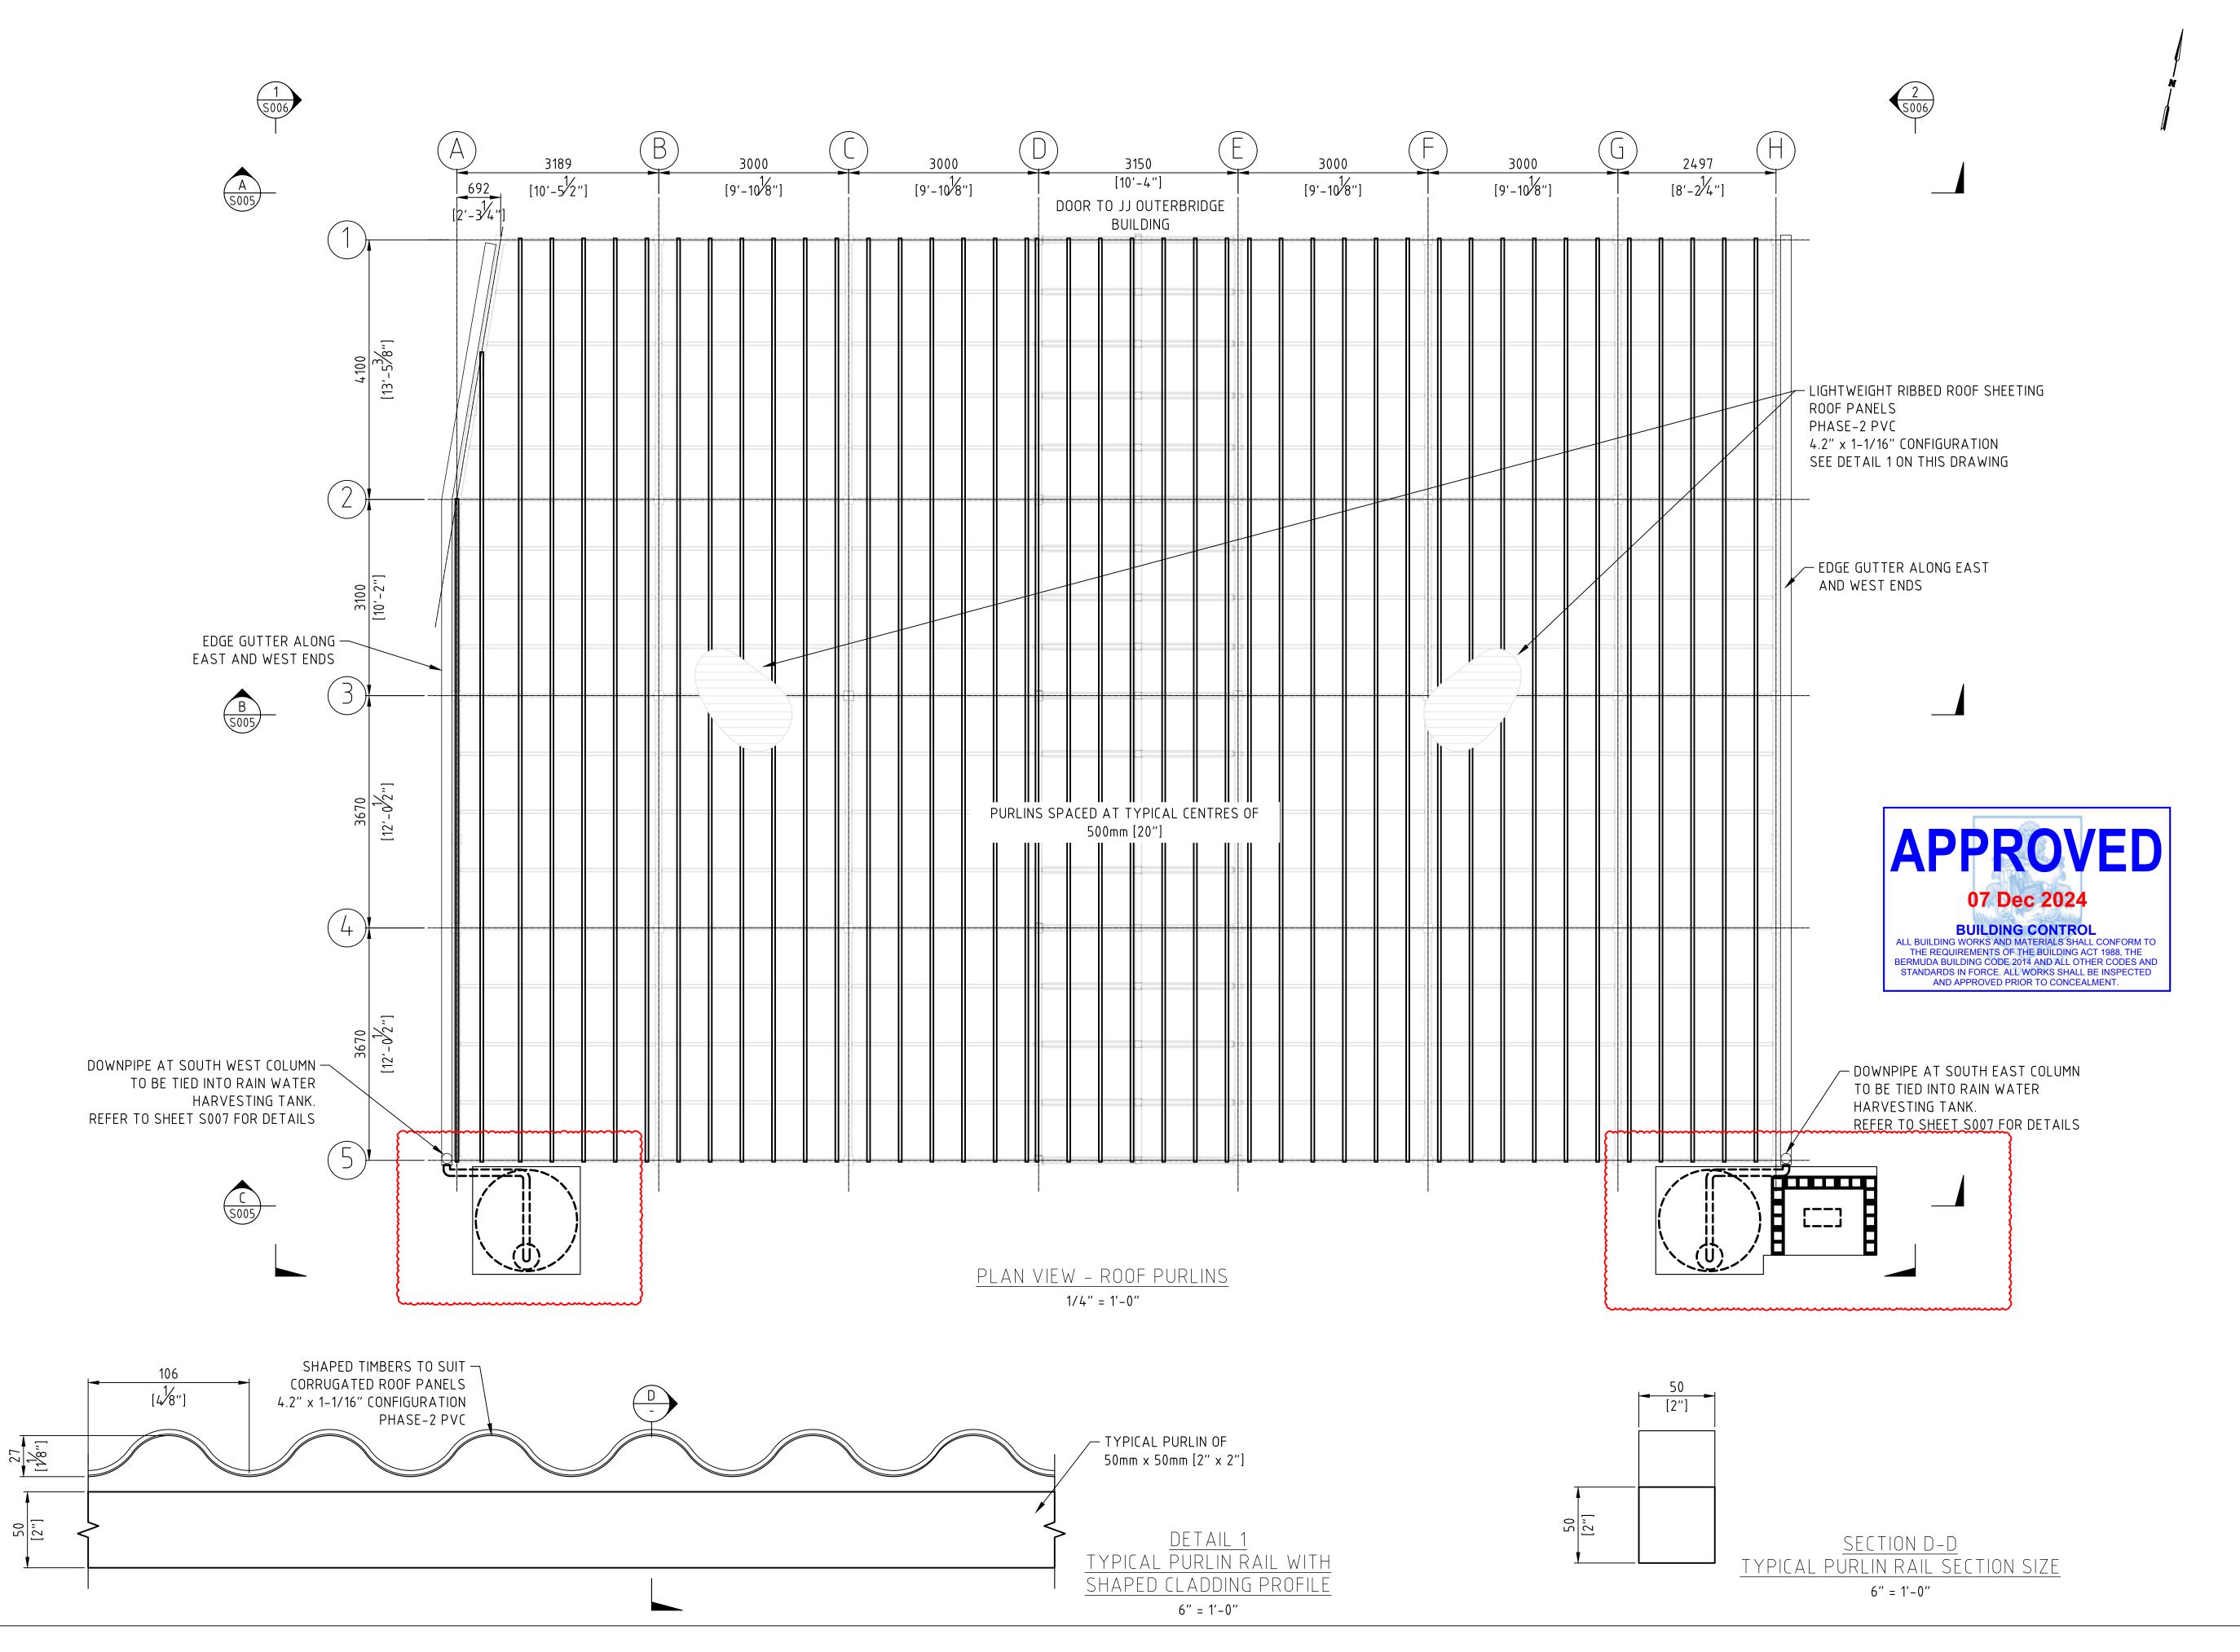
BOTANICAL GARDENS CACTI HOUSE REFURBISHMENTS

2024

SHEET TITLE:

GENERAL ARRANGEMENT ROOF LAYOUT

SHEET NUMBER: REVISION E



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В	REVISED FOLLOWING DESIGN TEAM COMMENTS	CF	1	04/07/2
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D	SCALES CHANGED AT REQUEST OF QS	CF		12/08/24
Е	TANK SLABS ADDED	CF	-	30/08/2

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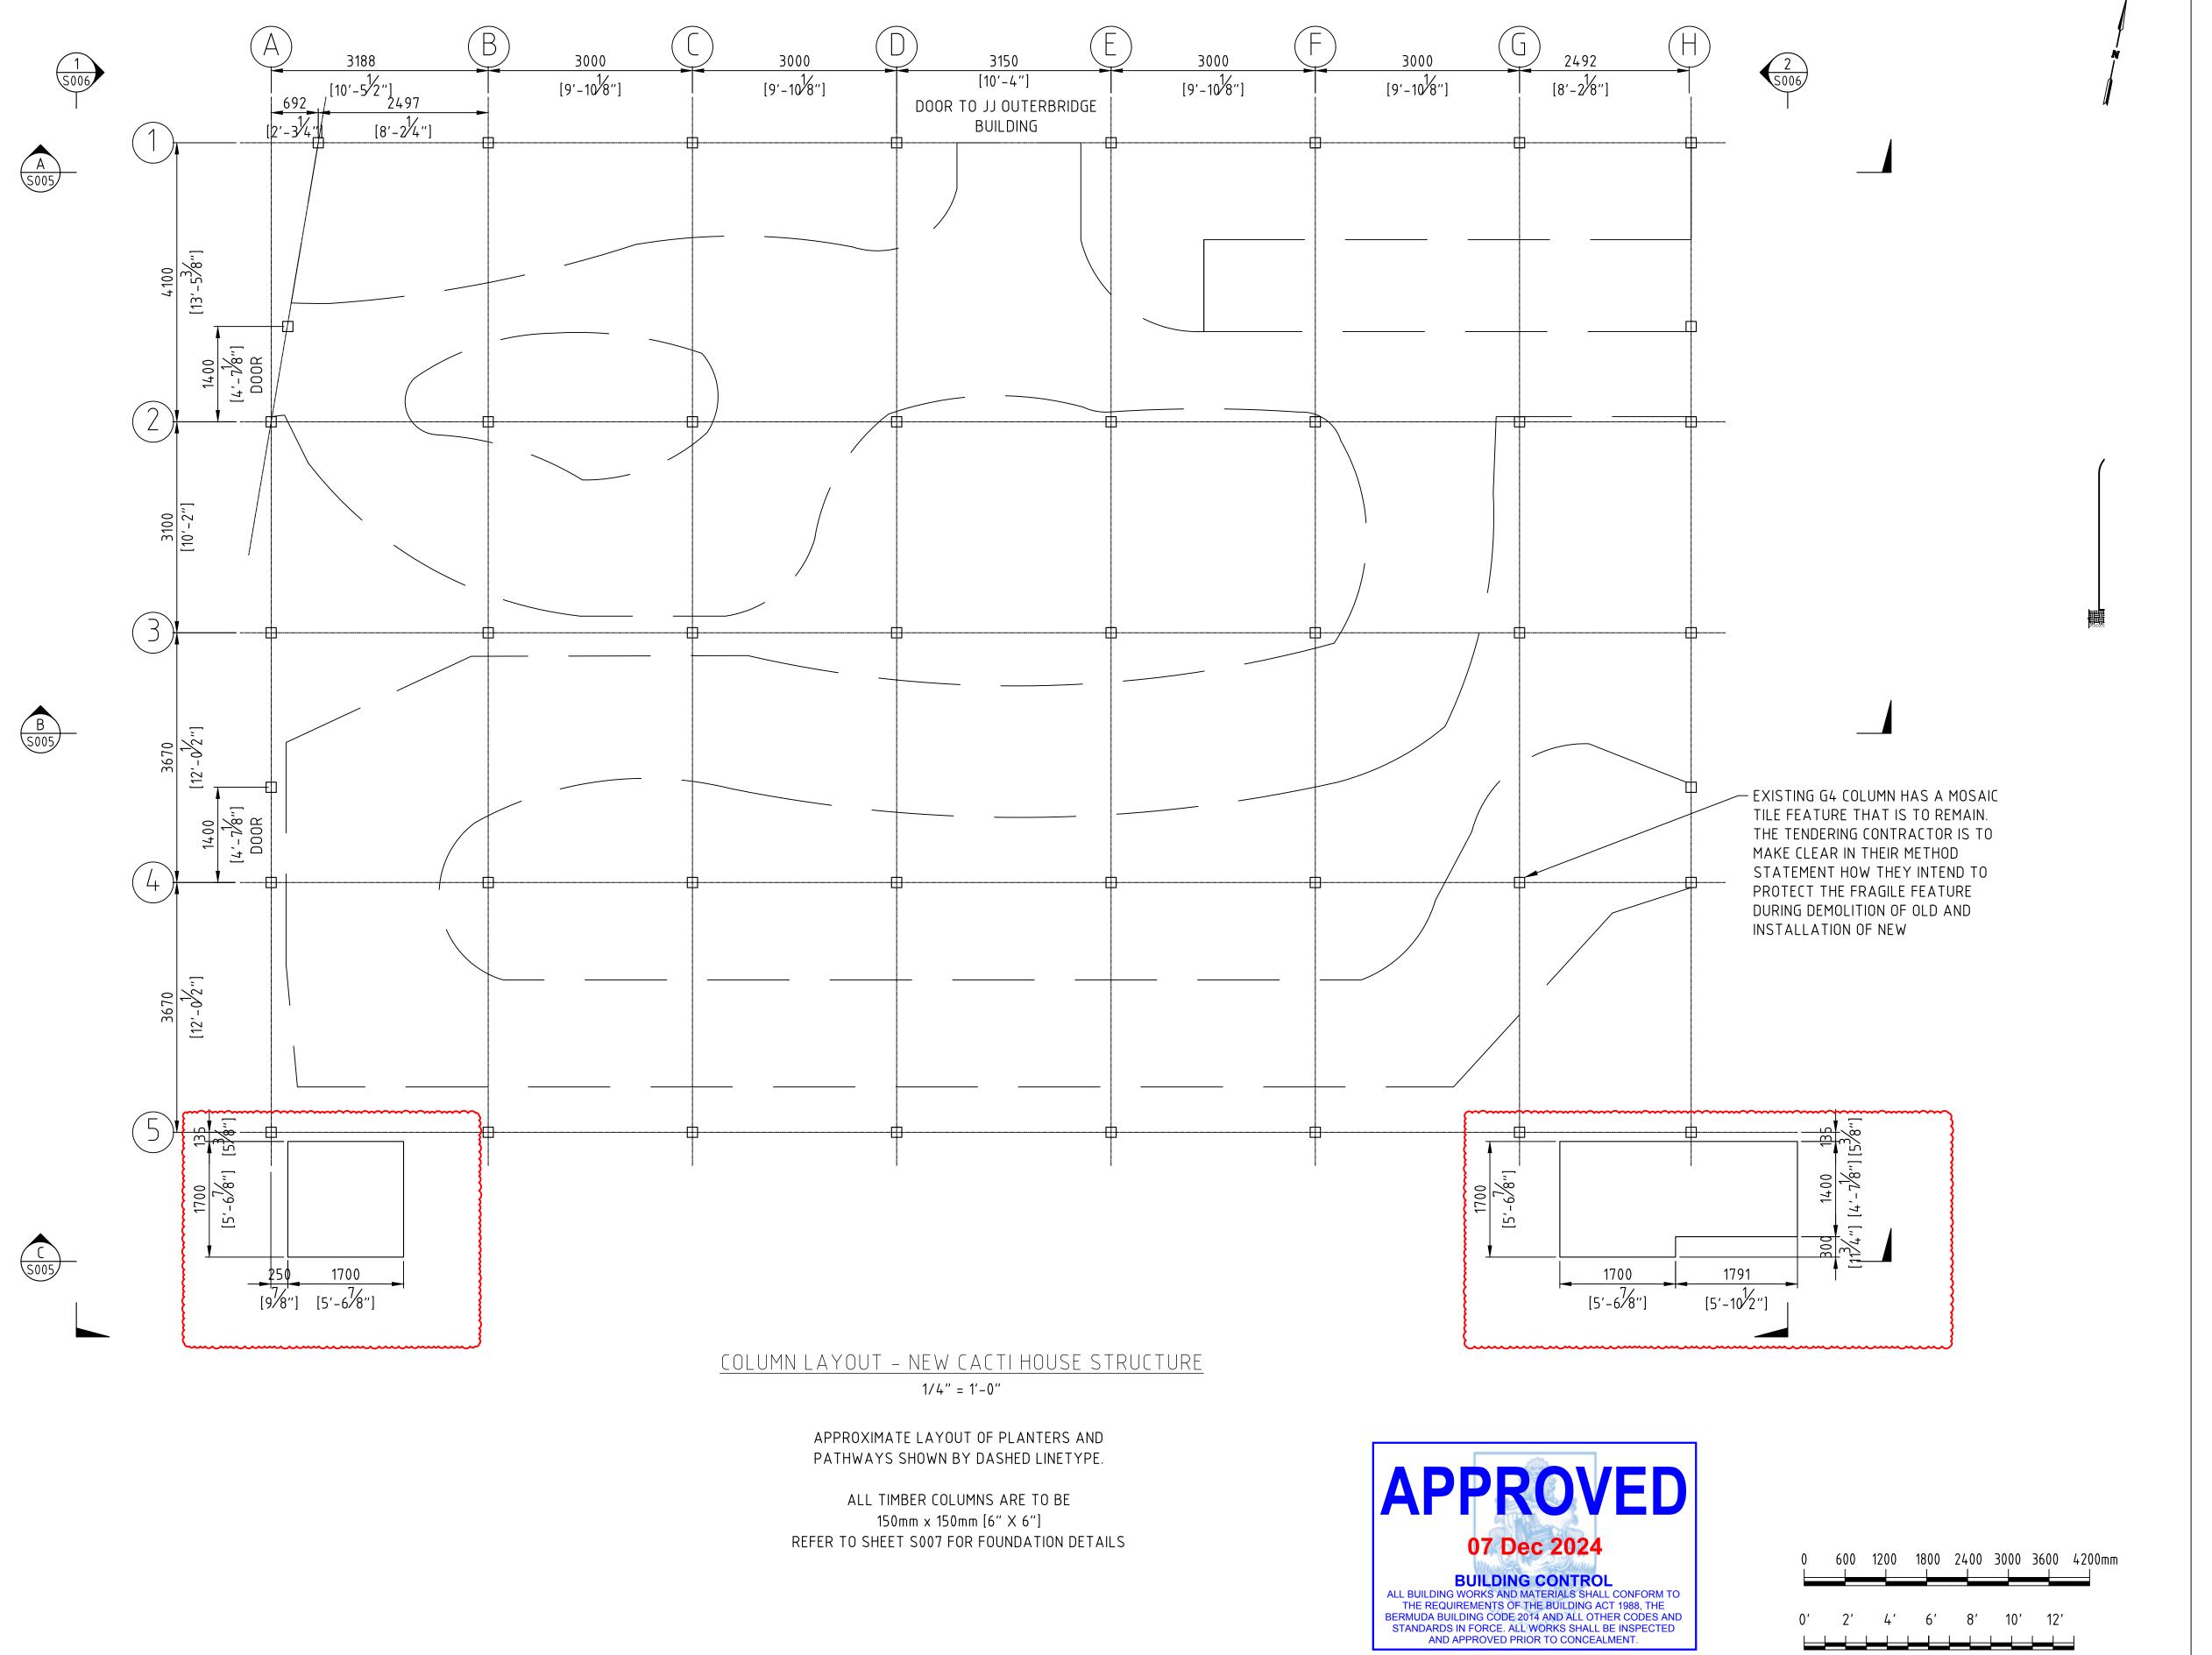
BOTANICAL GARDENS CACTI HOUSE REFURBISHMENTS

2024

SHEET TITLE:

GENERAL ARRANGEMENT ROOF PURLIN LAYOUT

SHEET NUMBER: REVISION E



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С	ISSUED FOR BUILDING PERMIT APPLICATION	CF	ı	12/07/24
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Е	TANK SLABS ADDED	CF	ı	30/08/2

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BOTANICAL GARDENS CACTI HOUSE REFURBISHMENTS


2024

SHEET TITLE:

SCALE 1/4" = 1'-0" AT ORIGINAL SIZE

GENERAL ARRANGEMENT COLUMN LAYOUT

SHEET NUMBER: REVISION S004

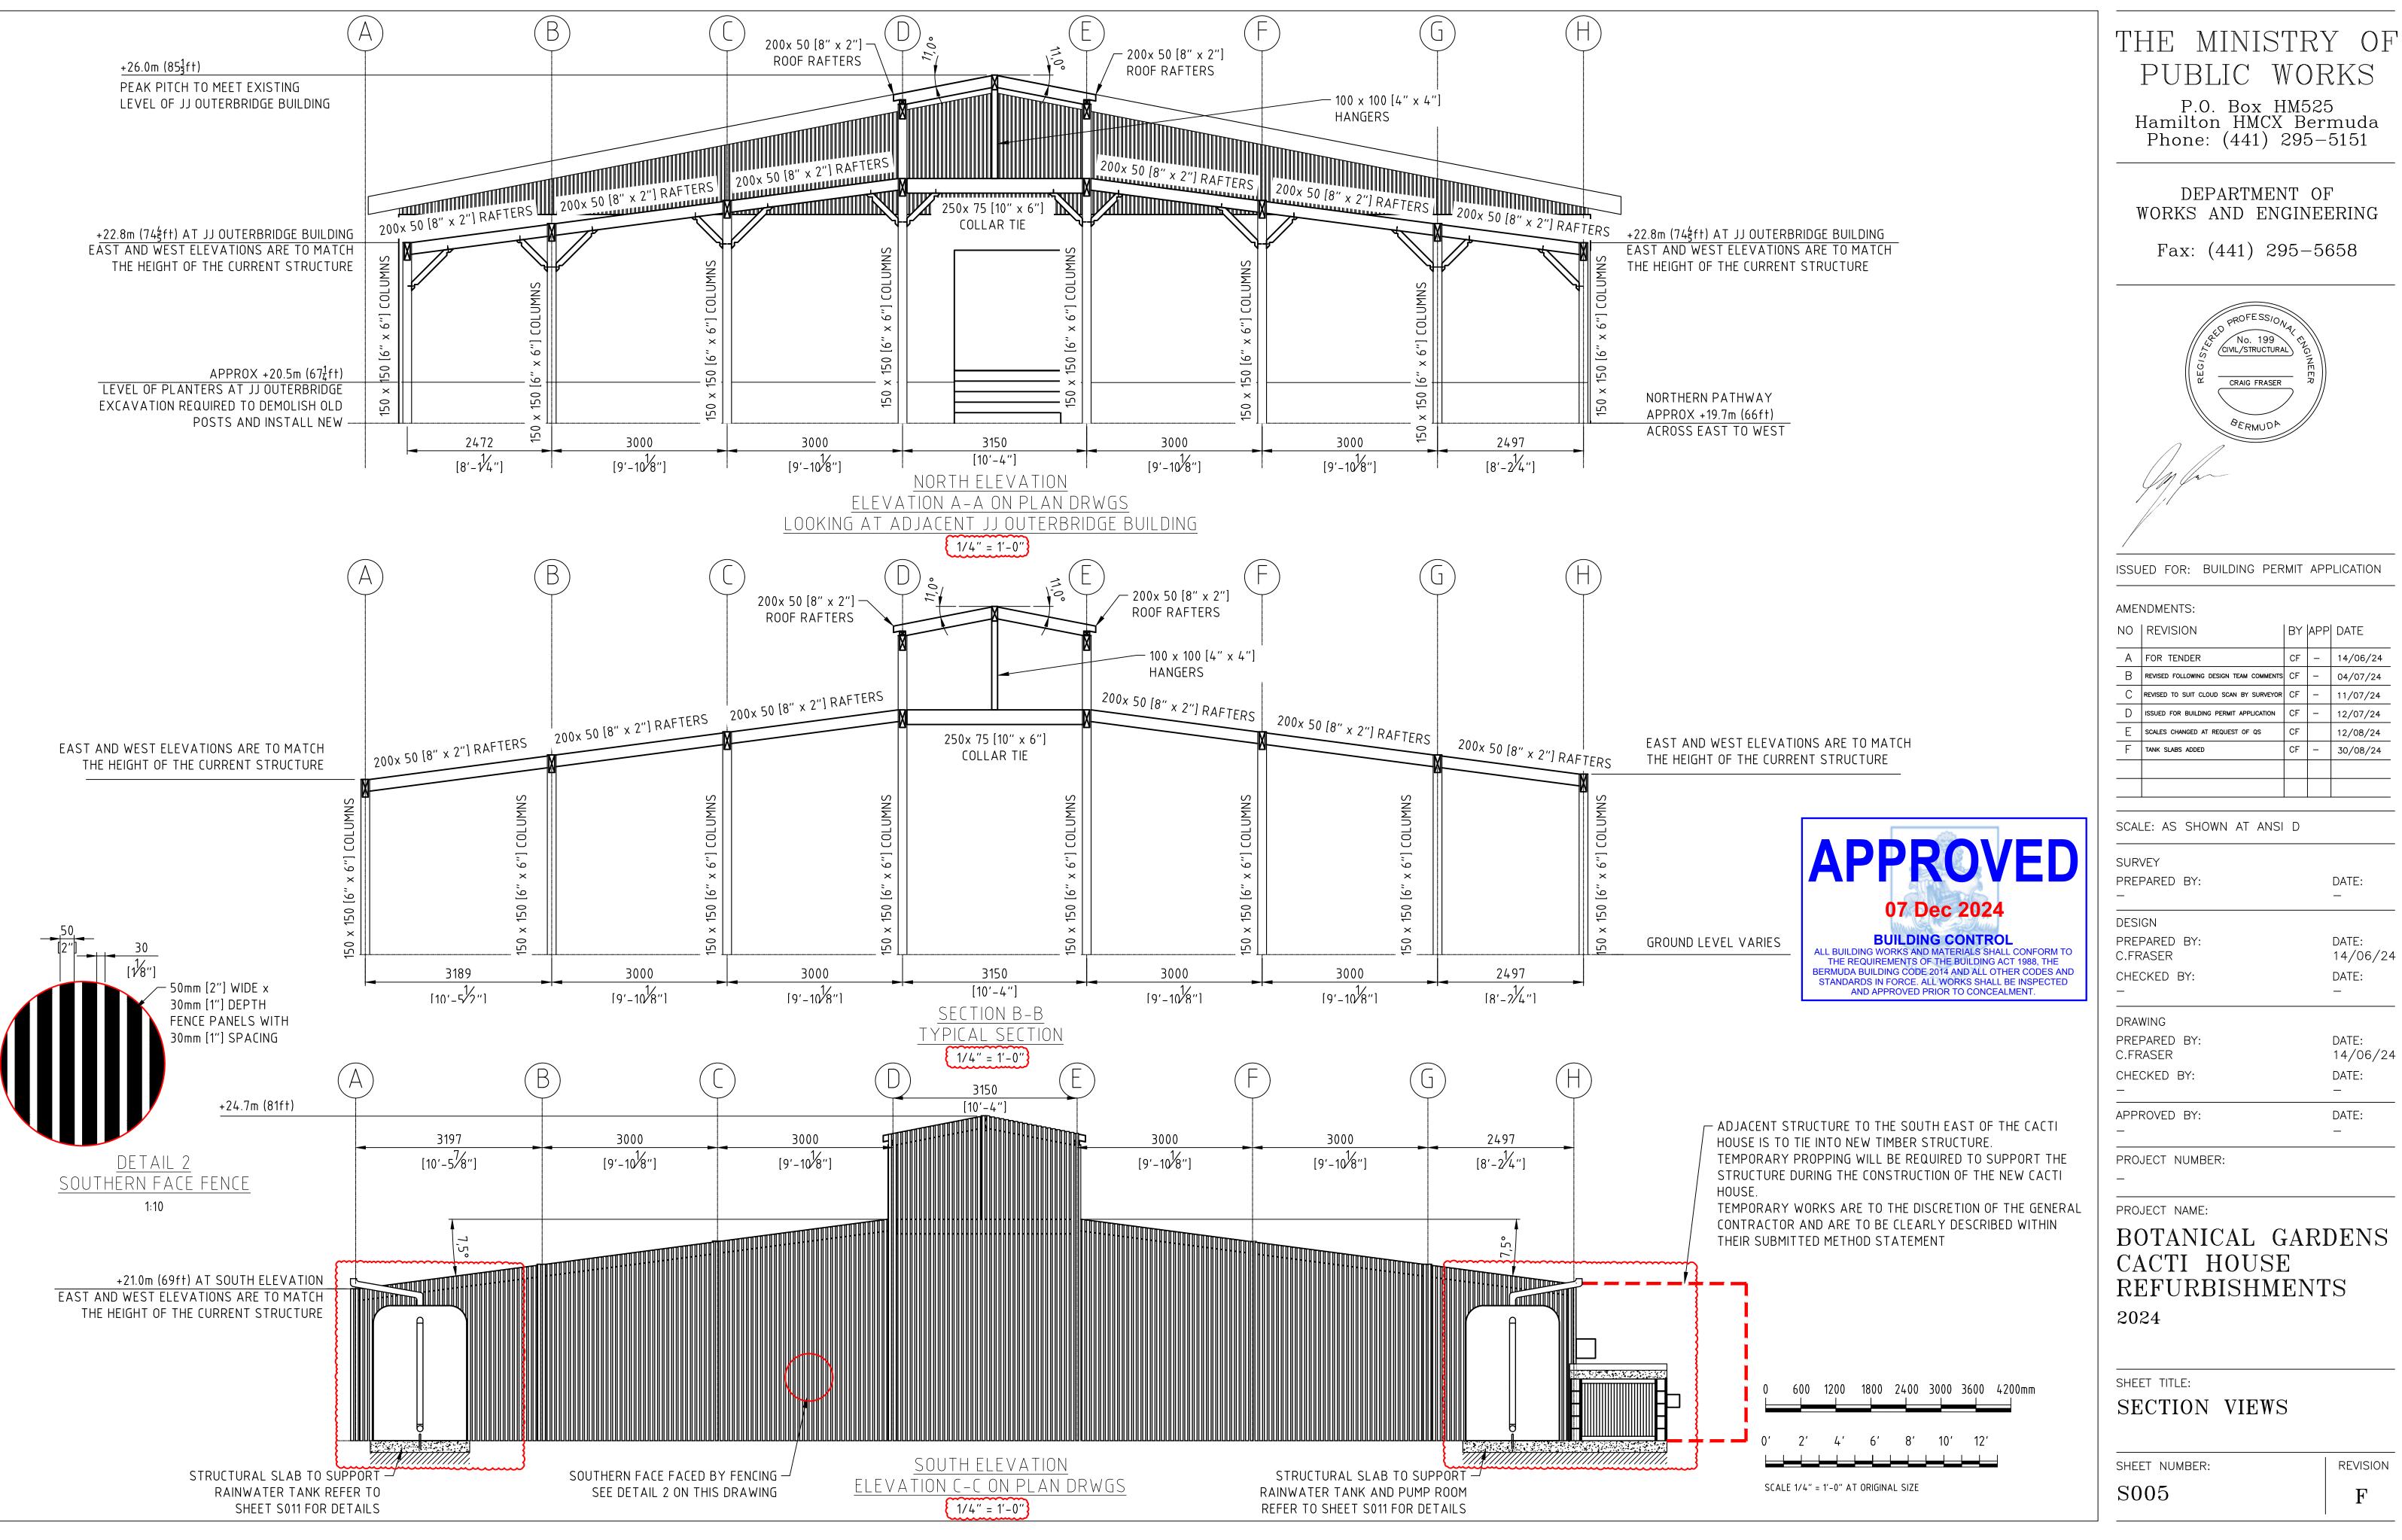


PUBLIC WORKS


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D	ISSUED FOR BUILDING PERMIT APPLICATION	CF	ı	12/07/24
Е	SCALES CHANGED AT REQUEST OF QS	CF		12/08/24
F	TANK SLABS ADDED	CF	ı	30/08/24

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PREPARED BY: C.FRASER	DATE: 14/06/2

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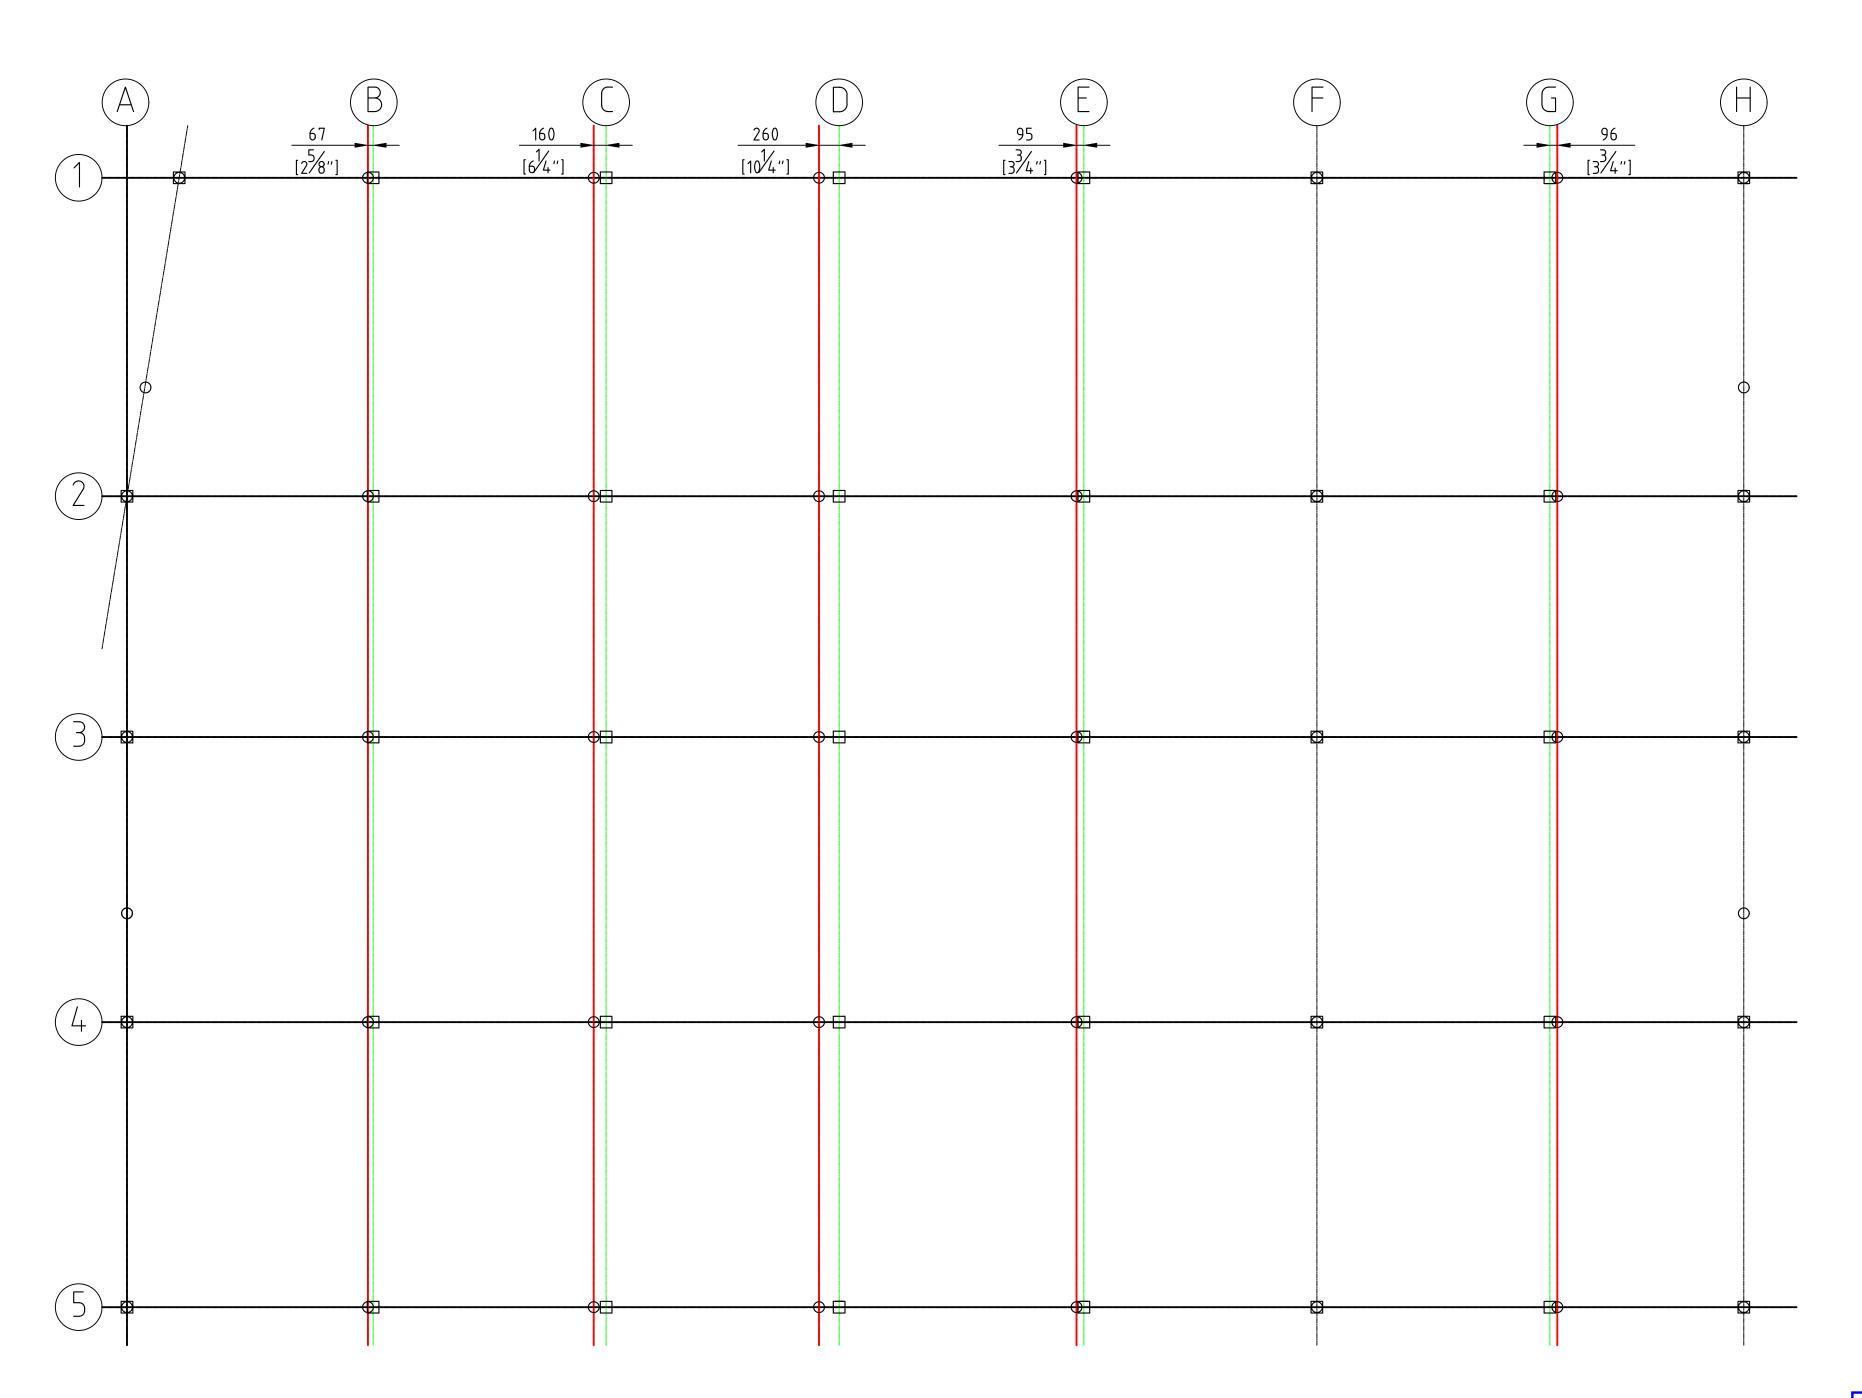
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С	ISSUED FOR BUILDING PERMIT APPLICATION	CF	ı	12/07/24
D	SCALES CHANGED AT REQUEST OF QS	CF		12/08/24
E	RAINWATER TANK CHANGED	CF	1	30/08/2

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BOTANICAL GARDENS REFURBISHMENTS
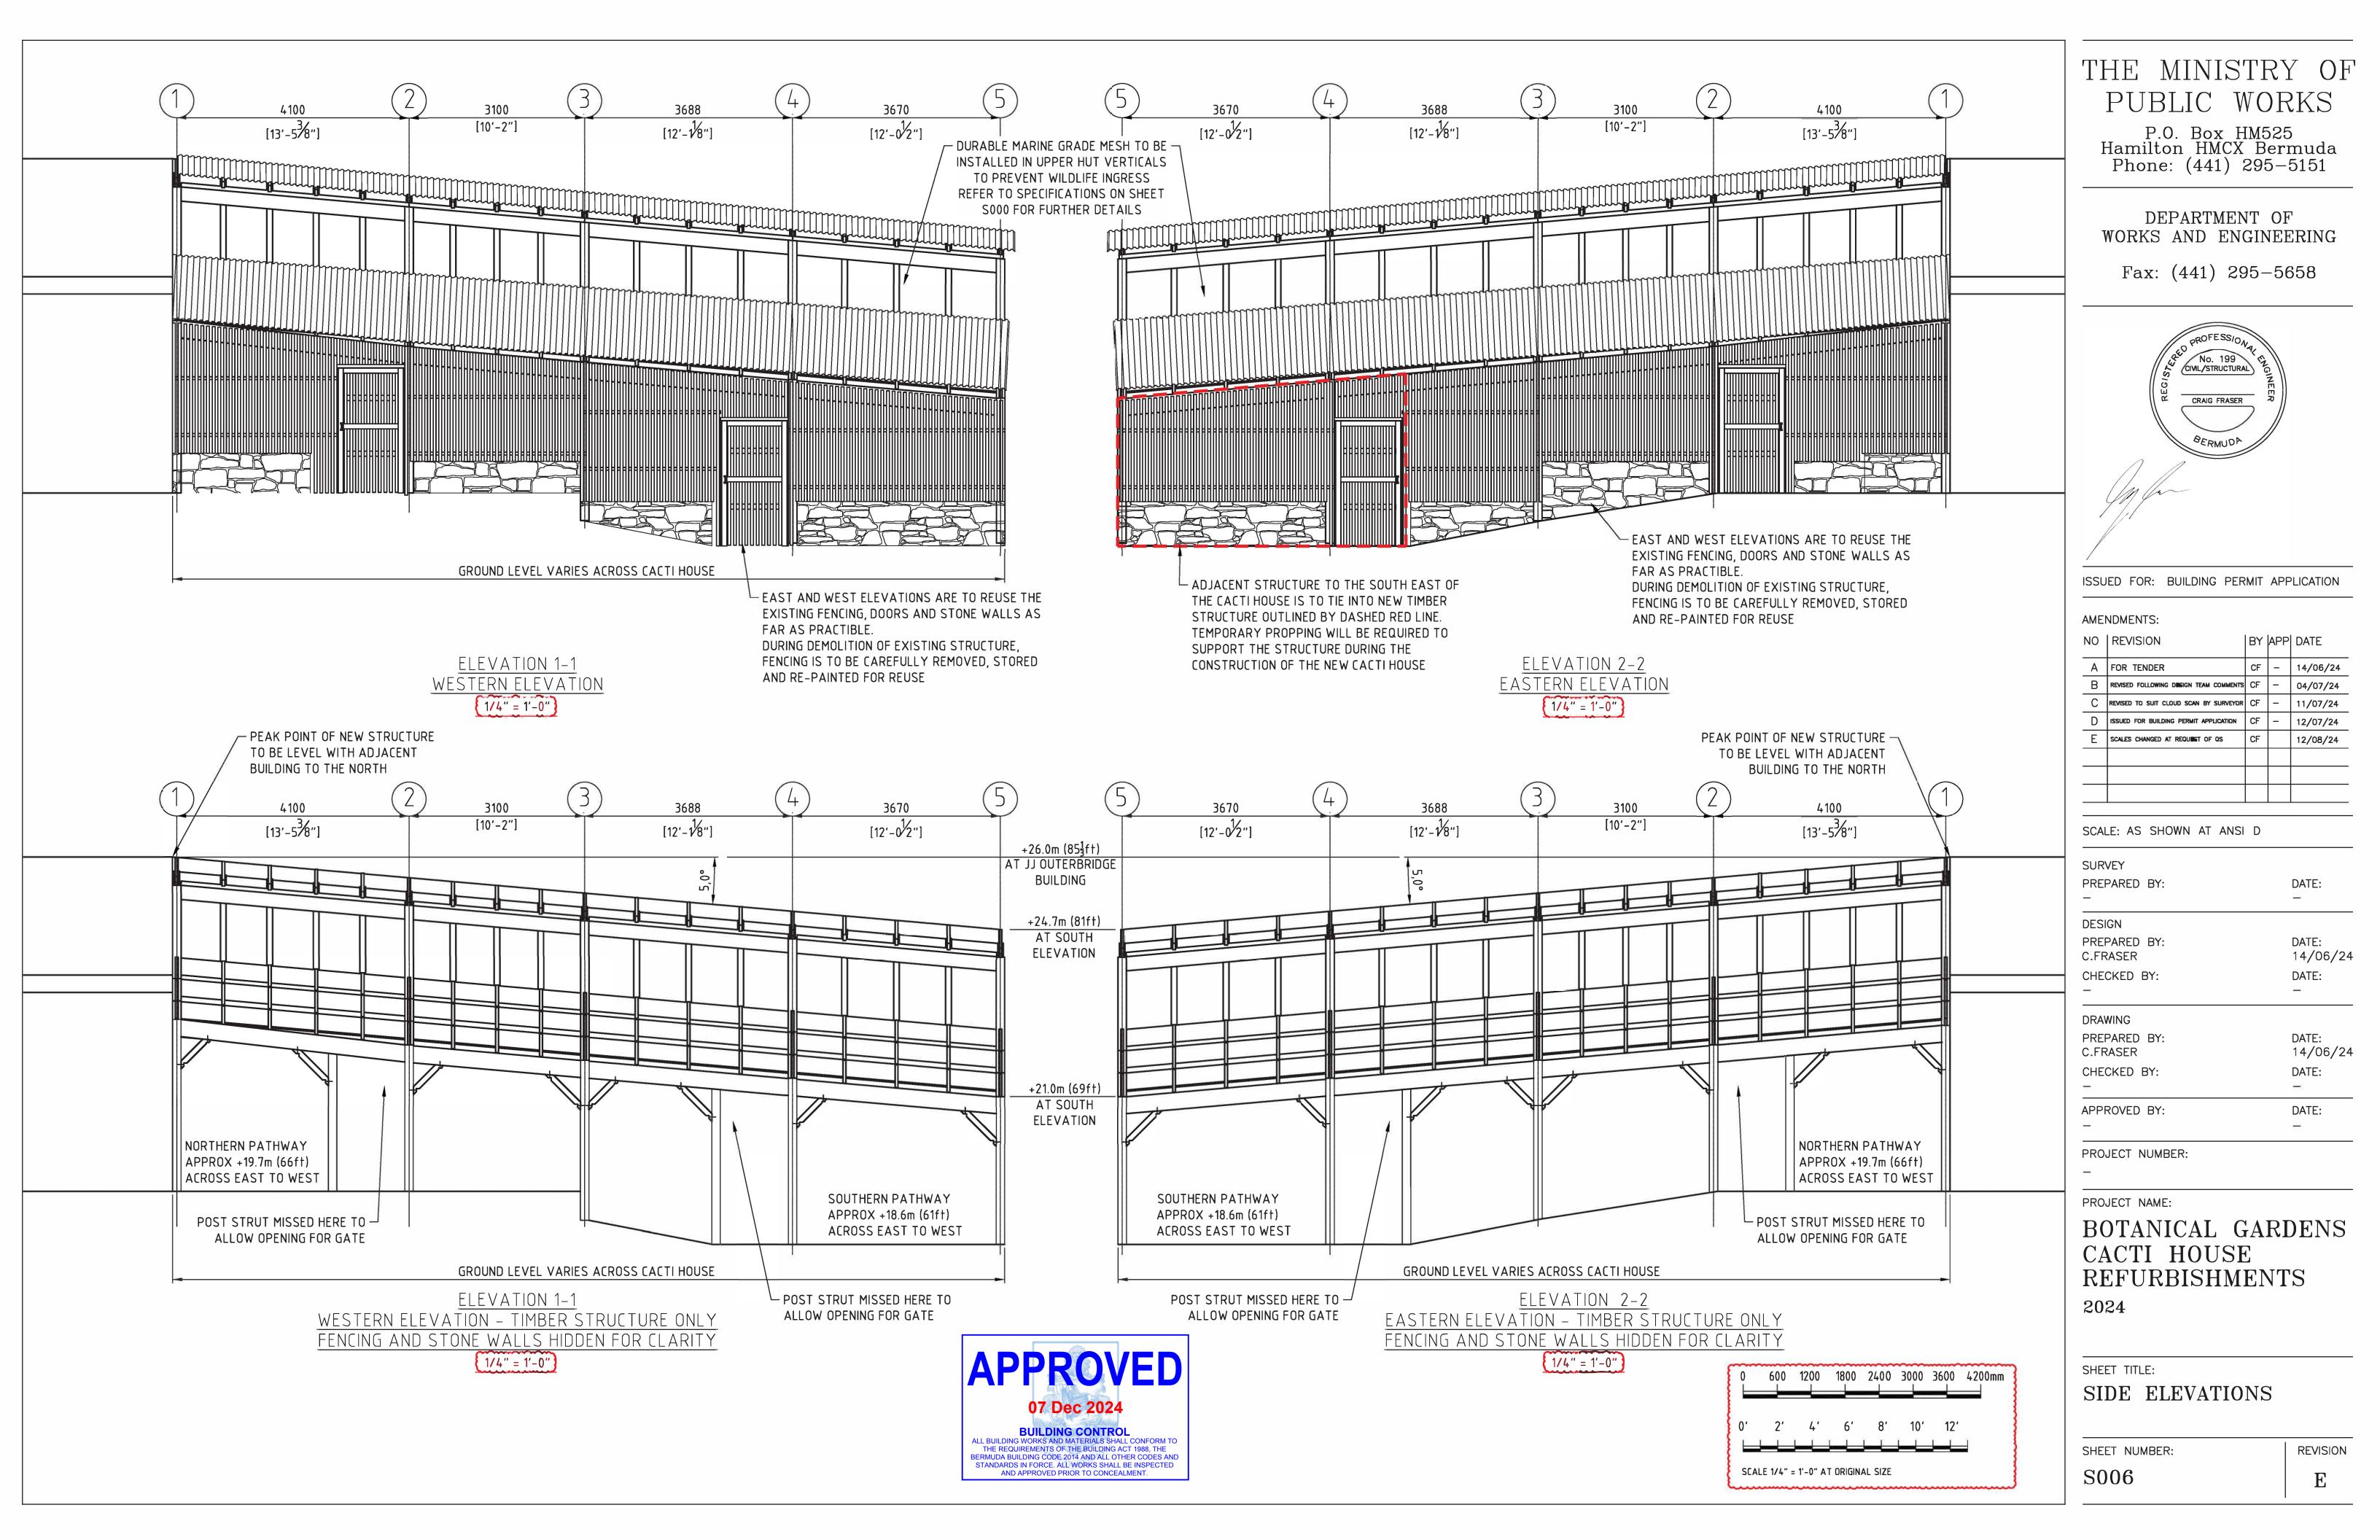
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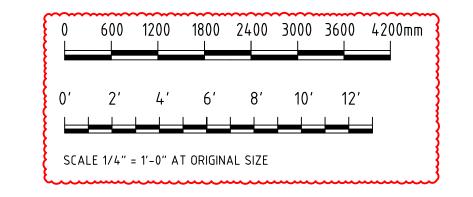


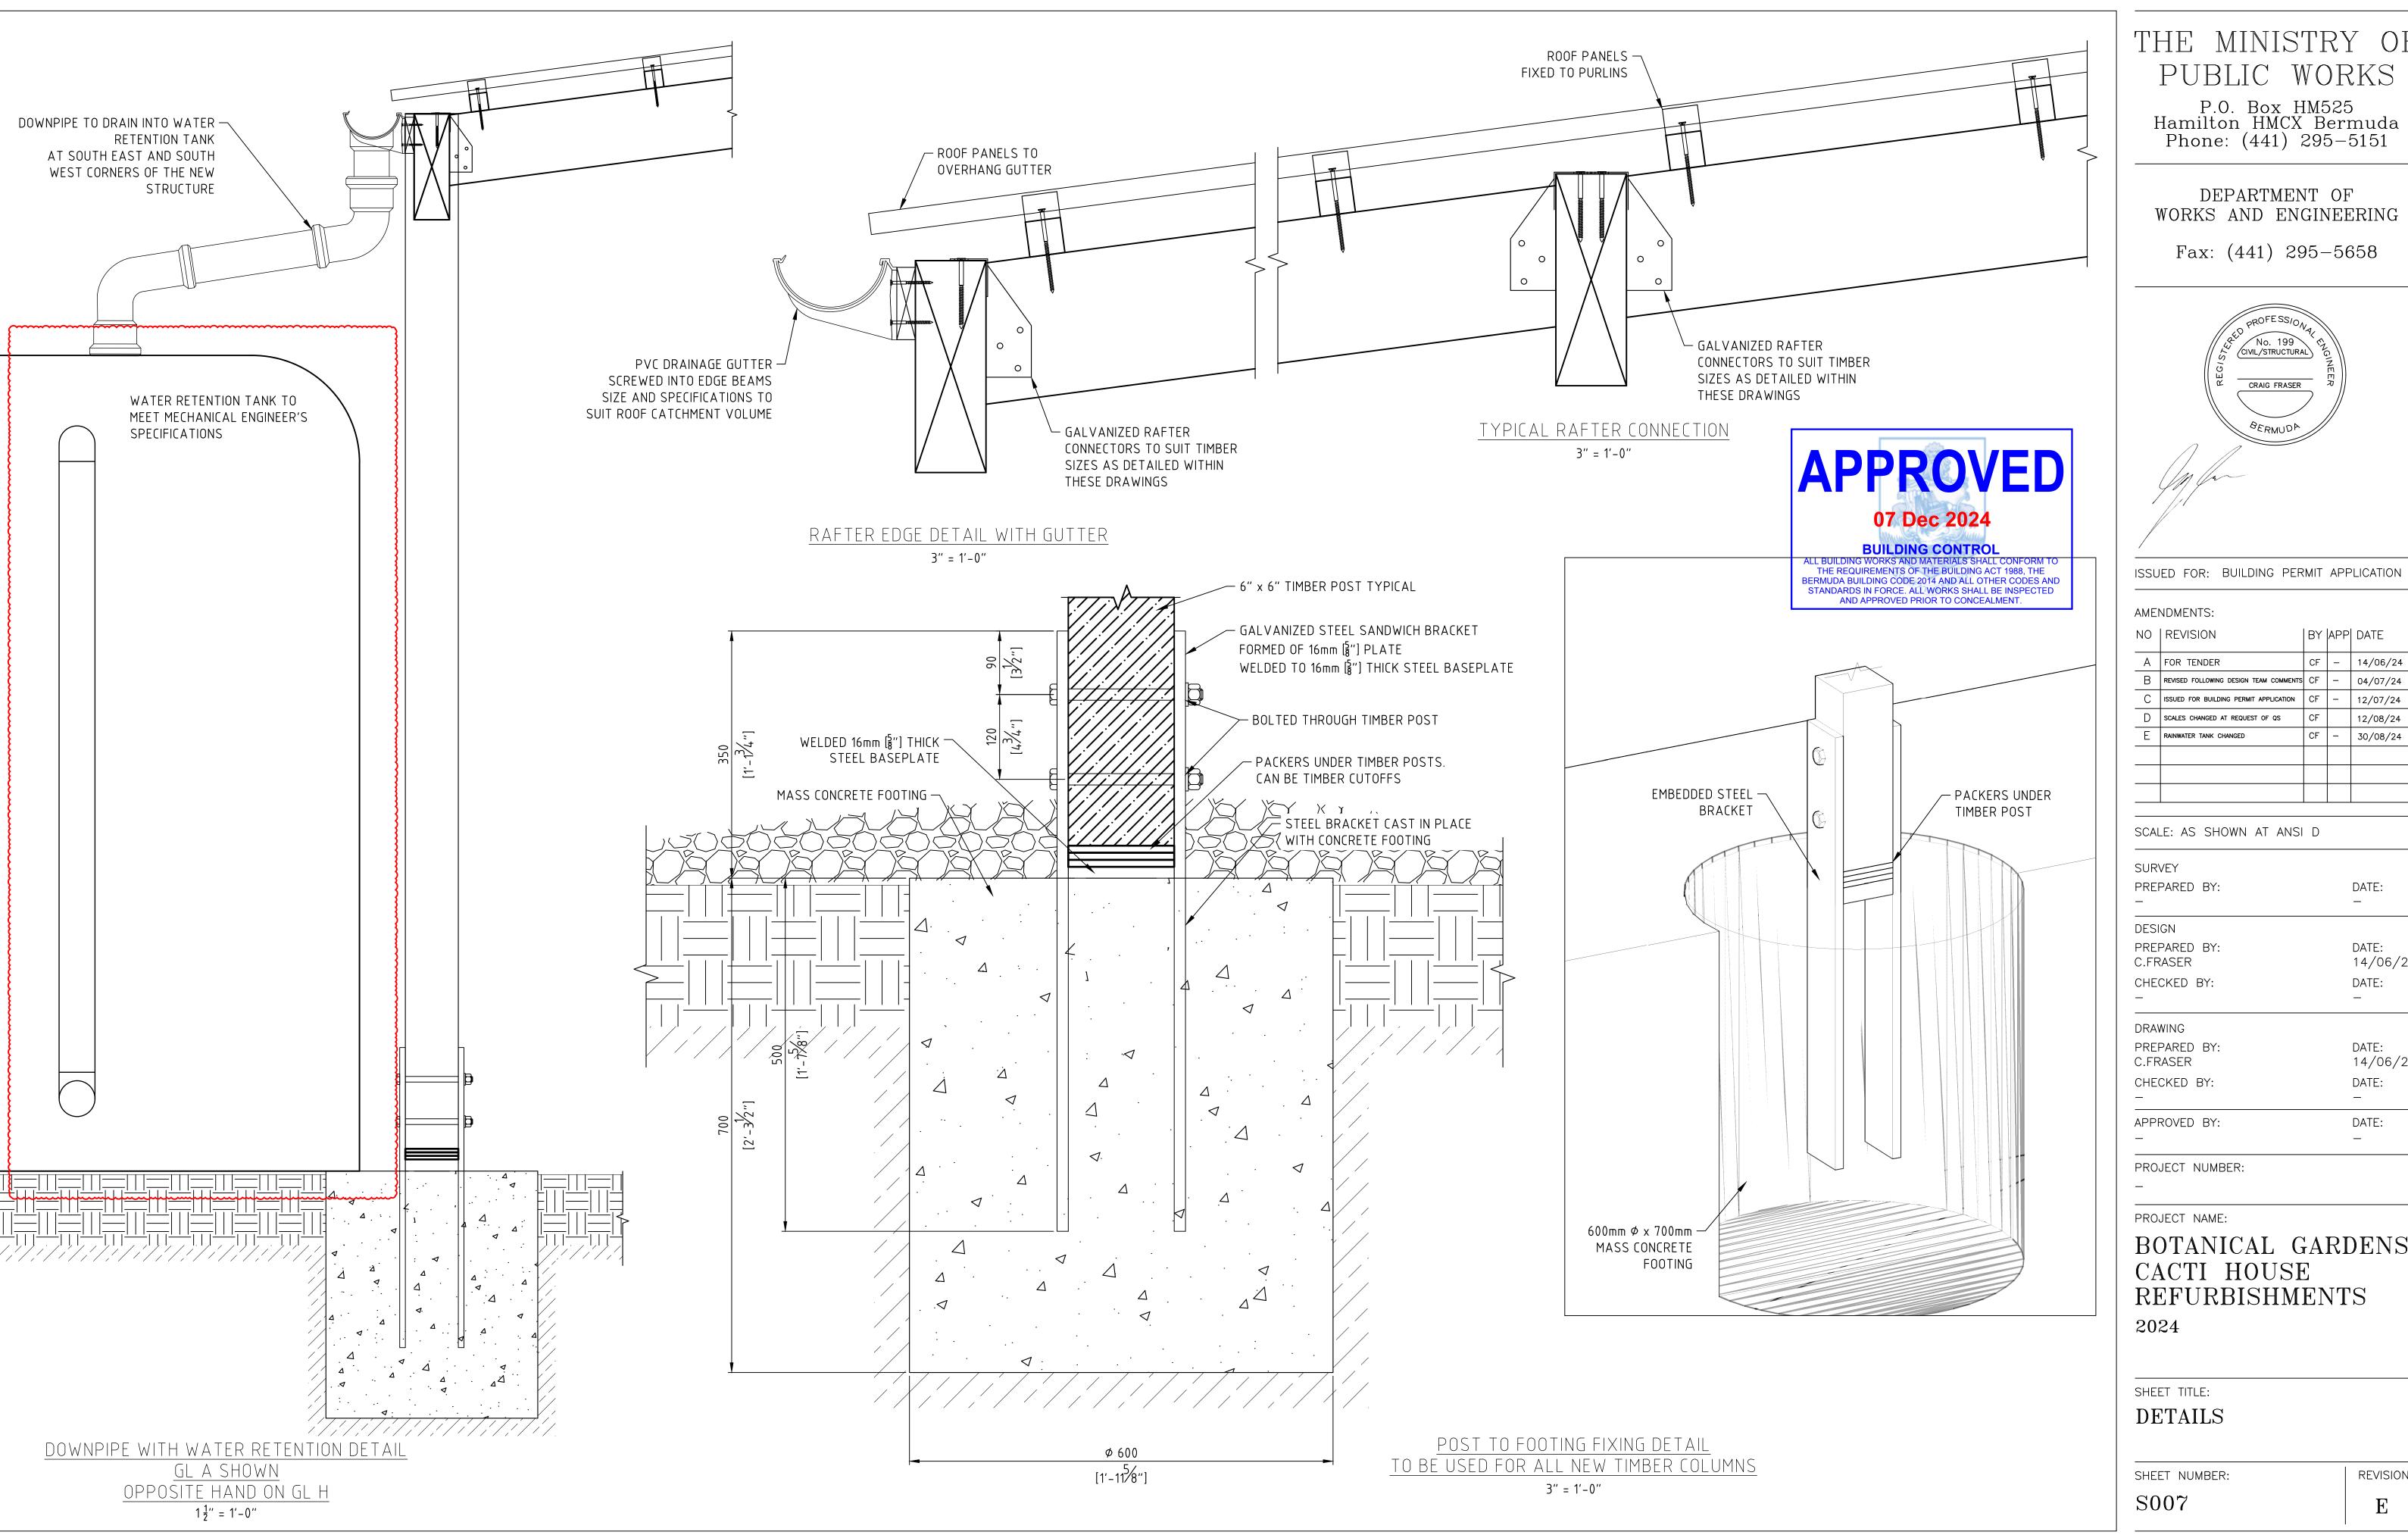COLUMN LAYOUT - NEW VS OLD 1/4" = 1'-0"

THE COLUMN LAYOUT OF THE NEW STRUCTURE IS MARGINALLY DIFFERENT TO THE OLD STRUCTURE TO BETTER ALIGN WITH THE ADJACENT NORTHERN BUILDING AND EVEN OUT COLUMN SPACINGS

RED GRIDLINES SHOW THE OLD COLUMN LAYOUT AND GREEN SHOW THE NEW, WITH DIMENSIONS INCLUDED TO HIGHLIGHT THE CHANGE.
WHEN GRIDLINES ARE BLACK, THERE IS NO DIFFERENCE BETWEEN OLD AND NEW





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BOTANICAL GARDENS CACTI HOUSE REFURBISHMENTS

2024


SHEET TITLE:

COLUMN LAYOUT OLD VS NEW LAYOUT

SHEET NUMBER: REVISION


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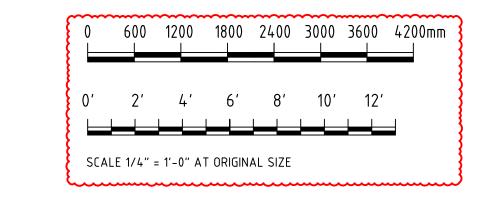


TYPICAL COLUMN STRUTS

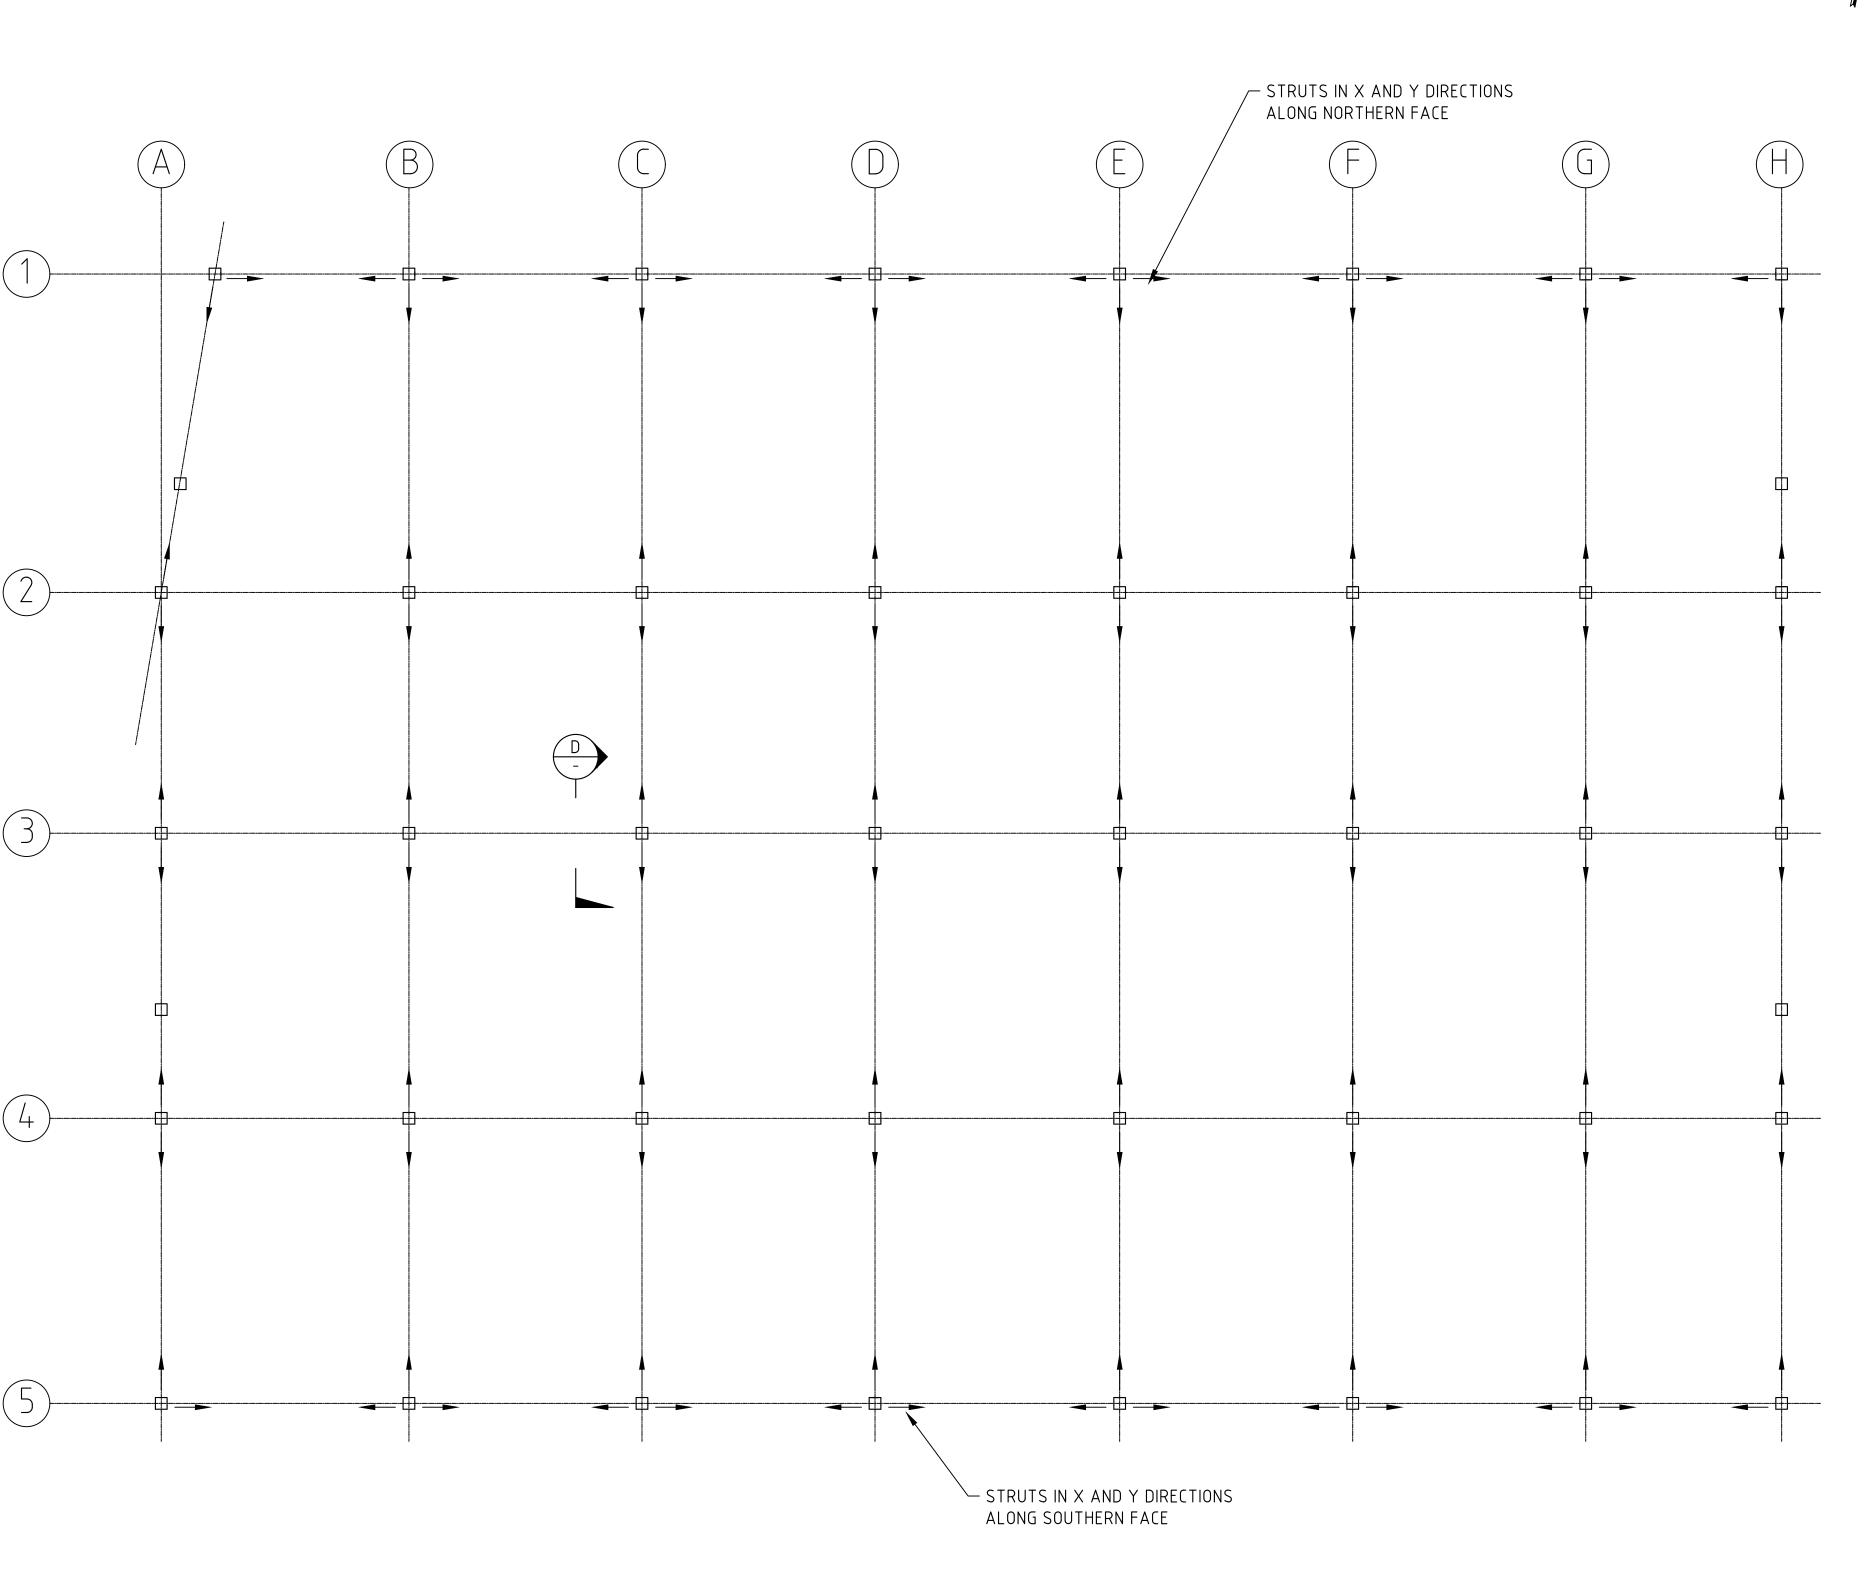SECTION D-D

1" = 1'-0"

COLUMNS REQUIRE TIE STRUTS AS SHOWN.
THE PLAN VIEW SHOWS THE DIRECTION STRUT TIES ARE TO BE INSTALLED.

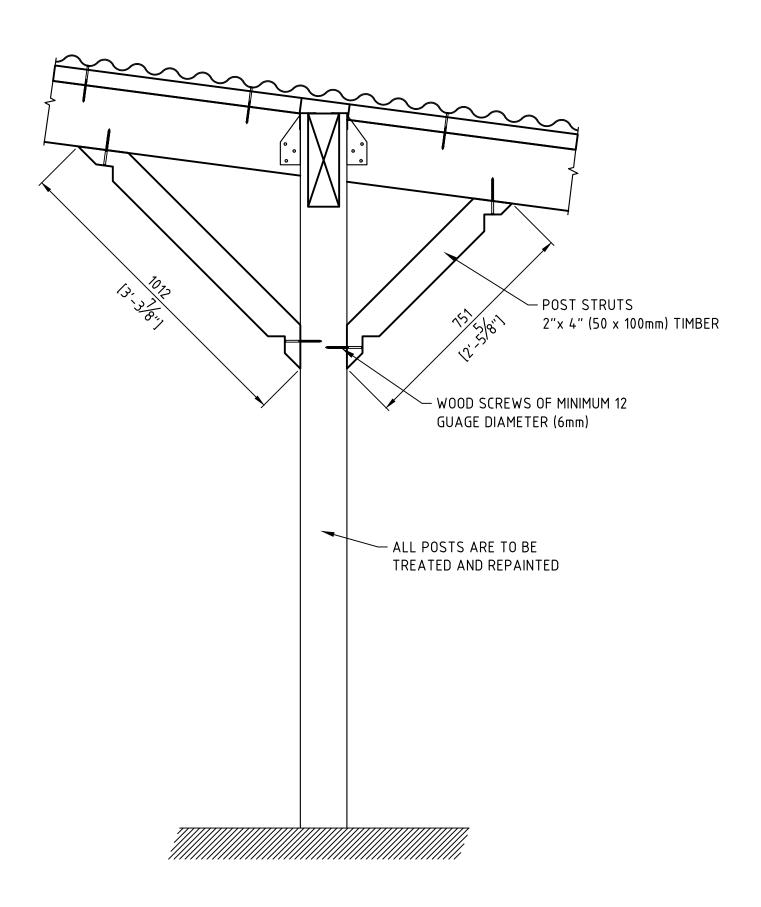

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CHECKED BY:

APPROVED BY:

PROJECT NAME:


BOTANICAL GARDENS CACTI HOUSE REFURBISHMENTS

2024

SHEET TITLE:

COLUMN STRUT LAYOUT PLAN

SHEET NUMBER: REVISION C

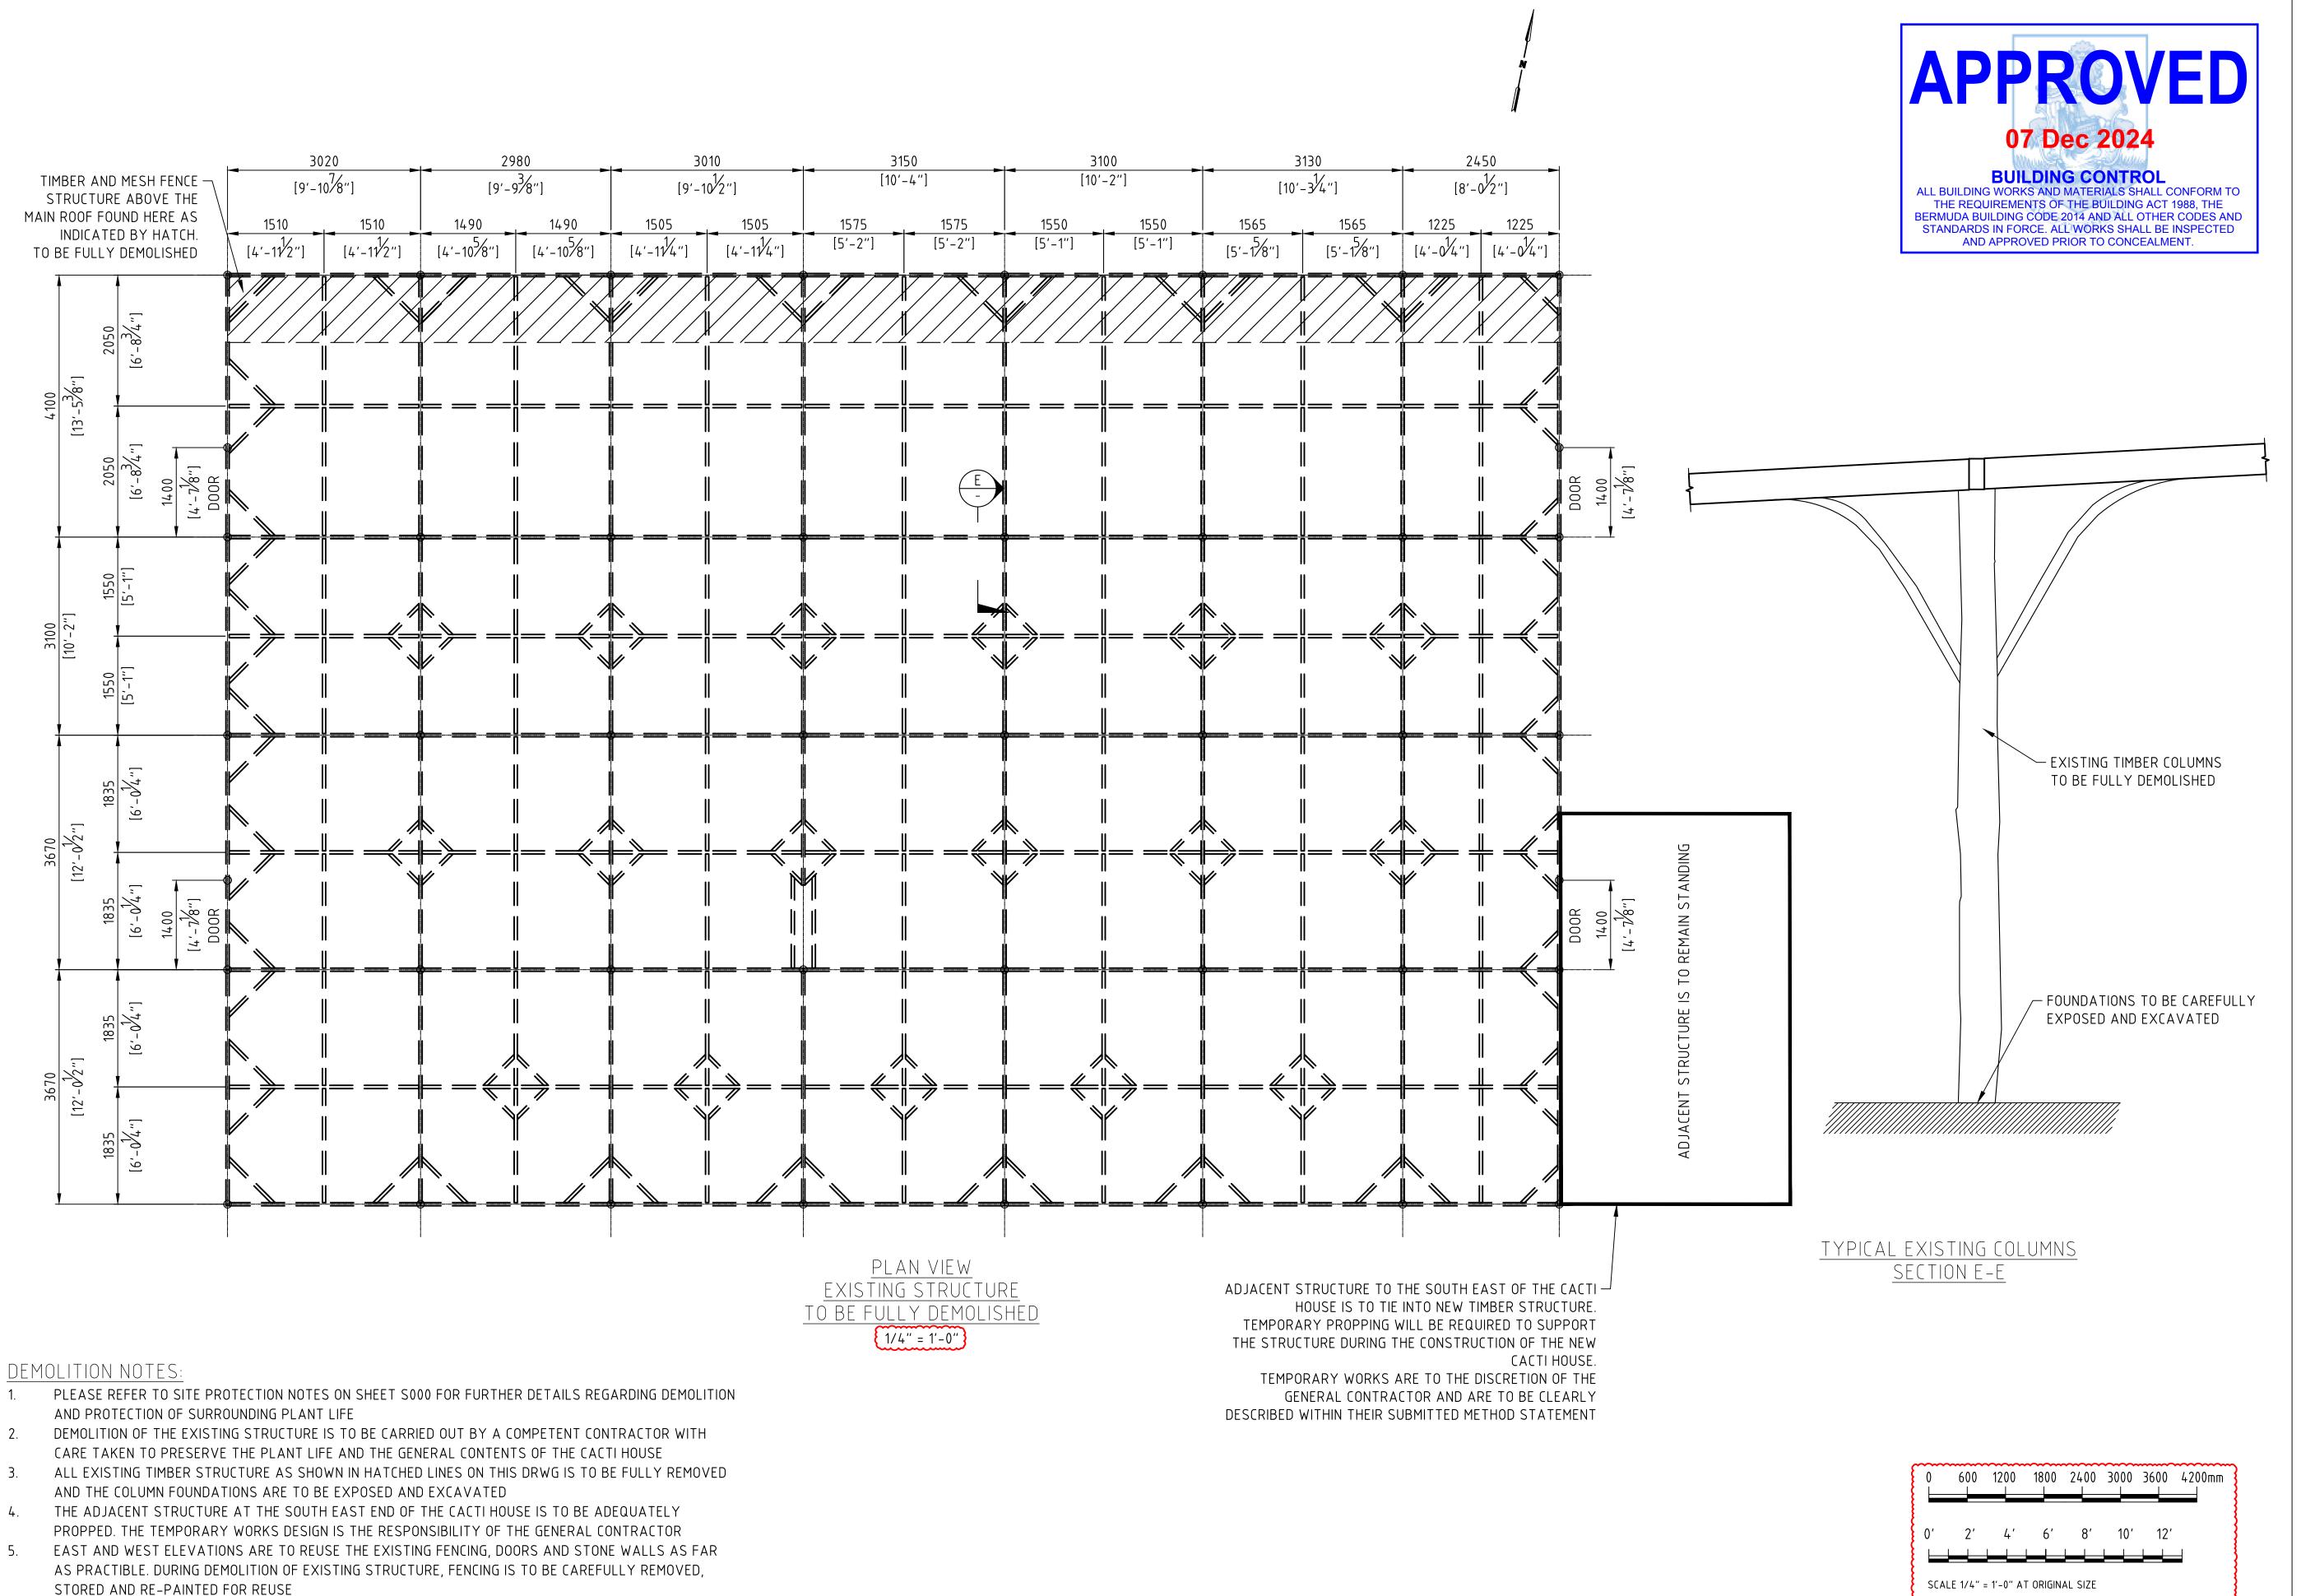

P.O. Box HM525 Hamilton HMCX Bermuda Phone: (441) 295-5151

DEPARTMENT OF WORKS AND ENGINEERING

Fax: (441) 295-5658



ISSUED FOR: BUILDING PERMIT APPLICATION

AMENDMENTS:

NO	REVISION	BY	APP	DATE
Α	FOR TENDER	CF	1	04/07/2
В	ISSUED FOR BUILDING PERMIT APPLICATION	CF	-	12/07/2
С	SCALES CHANGED AT REQUEST OF QS	CF		12/08/2

SCALE: AS SHOWN AT ANSI D

SURVEY	
PREPARED BY:	DATE:
DESIGN	
PREPARED BY: C.FRASER	DATE: 04/07/2
CHECKED BY:	DATE:
_	_
DRAWING	
PREPARED BY: C.FRASER	DATE: 04/07/2
CHECKED BY:	DATE:
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APPROVED BY:	DATE:
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PROJECT NUMBER:	

PROJECT NAME:


BOTANICAL GARDENS CACTI HOUSE REFURBISHMENTS

2024

SHEET TITLE:

DEMOLITION PLAN EXISTING STRUCTURE

SHEET NUMBER:	REVISION
S010	C

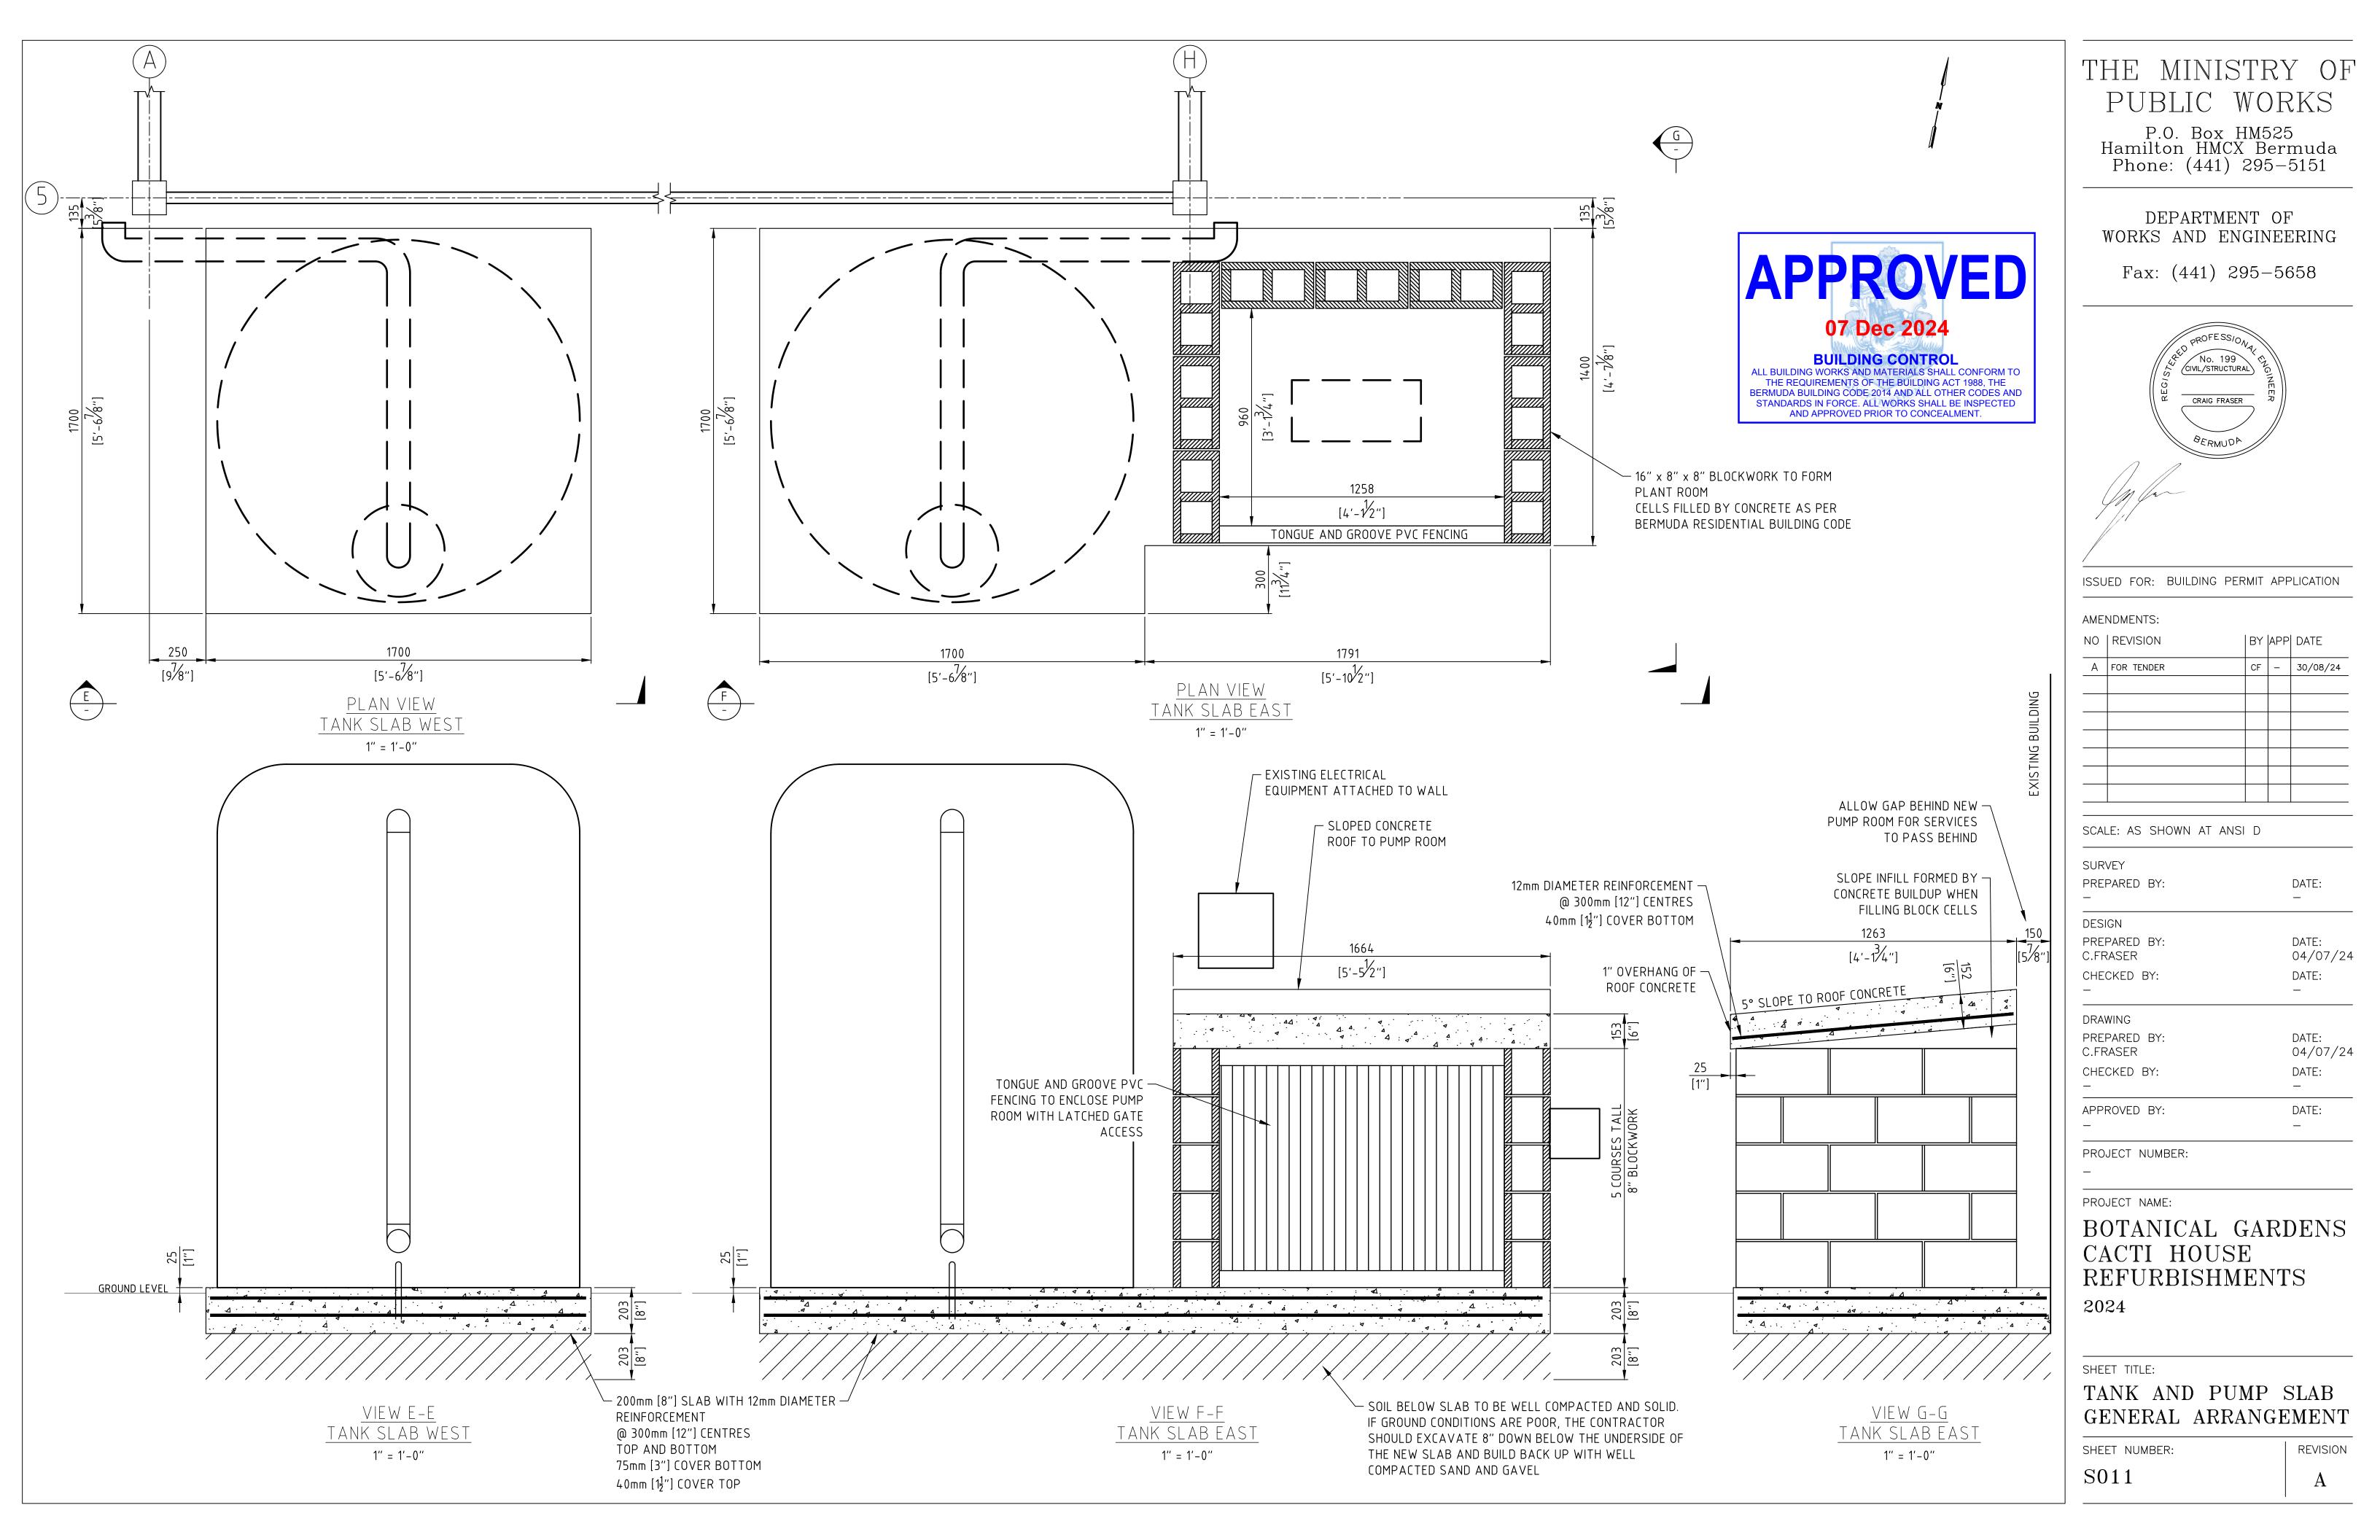

BOTANICAL GARDENS CACTI BUILDING WATER STORAGE SYSTEM

169 SOUTH ROAD, DEVONSHIRE, BM

A. BERMUDA DEPARTMENT OF PLANNING NOTES

- 1. ALL WORK SHALL COMPLY WITH APPLICABLE SECTIONS OF ALL LOCAL CODES AND AMENDMENTS TO DATE, INCLUDING BUT NOT LIMITED TO THE FOLLOWING:
- a. BERMUDA BUILDING CODE 2014 (ADOPTED FROM IBC 2012)
- b. BERMUDA MECHANICAL CODE 2014 (ADOPTED FROM IMC 2012)
- c. BERMUDA ELECTRICAL CODE 2014 (ADOPTED FROM NEC 2011) d. BERMUDA PLUMBING CODE 2014 (ADOPTED FROM IPC 2012)
- e. BERMUDA ENERGY CONSERVATION CODE 2014 (ADOPTED FROM IECC
- c. BERMUDA FIRE CODE 2014 (ADOPTED FROM NFPA STANDARDS)
- 2. ALL WORK SHALL COMPLY WITH THE REQUIREMENTS OF OF ALL APPLICABLE REFERENCE STANDARDS, INCLUDING BUT NOT LIMITED TO THE FOLLOWING: a. ANSI
- b. ASPE c. ASHRAE STANDARD 90.1: ENERGY STANDARD FOR BUILDINGS
- 3. ALL WORK SHALL BE SUBJECT TO SPECIAL INSPECTIONS AS APPLICABLE
- a. WIND RESISTANCE (IBC SECTION 1705.10)
- SPRAYED FIRE-RESISTANT MATERIALS (IBC SECTION 1705.13) MASTIC AND INTUMESCENT FIRE RATED COATINGS (IBC SECTION
- d. FIRE RESISTANT PENETRATION AND JOINTS (IBC SECTION 1705.16)
- e. ENERGY CODE INSPECTIONS
- 4. ALL WORK SHALL COMPLY WITH THE GOVERNMENT OF BERMUDA LAWS AND REGULATIONS, INCLUDING BUT NOT LIMITED TO: a. BERMUDA PUBLIC HEALTH ACT 1949
- b. BERMUDA OCCUPATIONAL SAFETY & HEALTH REGULATIONS 2009
- B. OCCUPATIONAL HEALTH, SAFETY AND ENVIRONMENT (OHSE) REQUIREMENTS
- 5. THE CONTRACTOR SHALL PROVIDE DIRECT SUPERVISION OVER THEIR WORKFORCE ON SITE, AND ENSURE THEIR WORK CONFORMS TO OHSE POLICIES.
- 6. THE CONTRACTOR SHALL SUPPLY AND UTILIZE THE APPROPRIATE PERSONAL PROTECTION EQUIPMENT (PPE) FOR ALL WORKS.
- 7. THE CONTRACTOR SHALL OBTAIN ALL NECESSARY AND APPLICABLE PERMITS OR APPROVALS.
- THE CONTRACTOR SHALL ELIMINATE OR CONTROL ALL SAFETY HAZARDS AND POTENTIAL ENVIRONMENTAL IMPACTS ASSOCIATED WITH THE PROJECT.

C. GENERAL NOTES

- 1. REMOVAL AND RELOCATION OF CERTAIN EXISTING WORK WILL BE NECESSARY FOR THE PERFORMANCE OF THE WORK. EXISTING CONDITIONS ARE NOT COMPLETELY DETAILED ON THE DRAWINGS. CONTRACTOR SHALL SURVEY THE SITE AND INCLUDE ALLOWANCE FOR SUCH REMOVALS AND RELOCATIONS.
- 2. WORK SHALL BE DONE WHEN AND AS DIRECTED AND SHALL BE PERFORMED SO AS TO CAUSE THE LEAST POSSIBLE INCONVENIENCE AND DISTURBANCE TO THE SURROUNDING POPULATION. PLAN INSTALLATION OF NEW WORK AND CONNECTIONS TO EXISTING WORK TO AVOID INTERFERENCE WITH REGULAR OPERATION OF EXISTING FACILITIES.
- 3. MATERIALS, DOCUMENTATION AND WORKMANSHIP SHALL BE IN ACCORDANCE WITH LOCAL CODES, REFERENCE STANDARDS, AND AS SPECIFIED.
- 4. DISCONNECT, REMOVE AND/OR RELOCATE EXISTING MATERIALS, EQUIPMENT AND OTHER WORK AS NOTED OR REQUIRED FOR PROPER INSTALLATION OF NEW WORK.
- 5. FIREPROOFING AND INSULATION DISTURBED BY NEW CONSTRUCTION SHALL BE RESTORED TO ORIGINAL CONDITION.
- 6. SUPPORT ALL PIPING AND/OR EQUIPMENT FROM BUILDING STRUCTURE, FLOORS, AND BURIED IN TRENCH IN AN APPROVED MANNER. WHERE OVERHEAD CONSTRUCTION DOES NOT PERMIT FASTENING OF SUPPORTS FOR EQUIPMENT, FURNISH ADDITIONAL FRAMING.
- 7. SEAL OPENINGS AROUND PIPING THROUGH WALLS AND FOUNDATION SLABS IN AN APPROVED MANNER USING MINERAL WOOL OR OTHER NON-COMBUSTIBLE MATERIAL. ALL PENETRATIONS SHALL BE FIRE-PROOFED, AS REQUIRED.
- 8. CONTRACTOR TO PROVIDE FULLY COORDINATED SHOP DRAWINGS AND SUBMITTALS FOR THE ENGINEER'S REVIEW PRIOR TO PROCUREMENT, FABRICATION, OR INSTALLATION OF NEW WORK.
- 9. CONTRACTOR SHALL USE EXTREME CAUTION WHEN INSTALLING FIXTURES OR PIPING ON OR IN FINISHED WALLS AND PARTITIONS.
- 10. PROVIDE ANGLE STOPS ON WATER PIPING AT ALL FIXTURES.
- 11. CONTRACTOR SHALL VERIFY EXACT LOCATION OF EXISTING PIPING IN FIELD BEFORE ANY INSTALLATION OF NEW WORK.
- 12. FOR EXACT LOCATION OF PLUMBING FIXTURES, REFER TO ARCHITECTURAL DRAWINGS.

- 13. ALL PLUMBING WORK SHALL COMPLY WITH BUILDING STANDARDS AND
- 14. ALL NEW PLUMBING FIXTURES SHALL COMPLY WITH WATER CONSERVATION LAWS.
- ALL FIXTURES SHALL BE AS SPECIFIED BY ARCHITECT, FURNISHED AND INSTALLED BY PLUMBING CONTRACTOR.
- 16. CONTRACTOR SHALL PROVIDE TRAP PRIMERS FOR ALL FLOOR DRAINS
- 17. CONTRACTOR SHALL PROVIDE ACCESS DOORS TO ALL DOMESTIC WATER VALVES AND TRAP PRIMERS.
- 18. CONTRACTOR SHALL PROVIDE WATER HAMMER ARRESTORS ON ALL QUICK CLOSING
- 19. CONTRACTOR TO FIRE PROOF AND SEAL ALL PENETRATIONS THROUGH EXTERIOR WALLS IN AN APPROVED MANNER

D. DEMOLITION

- 1. CONTRACTOR SHALL OBTAIN ALL REQUIRED PERMITS BEFORE ANY WORK IS BEGUN
- 2. ALL EXITS SHALL BE KEPT READILY ACCESSIBLE AND UNOBSTRUCTED AT ALL TIMES.
- 3. ALL WASTE AND DEBRIS SHALL BE REMOVED IN APPROVED CONTAINERS ON A DAILY
- 4. ALL EXISTING PLUMBING FIXTURES NO LONGER IN USE SHALL BE REMOVED WITH
- REMOVE UNUSED WASTE PIPING AND PATCH FLOOR PENETRATION AS REQUIRED.

ASSOCIATED PIPING. PLUG AND CAP AT SOURCE ALL UNUSED PIPING.

- 6. ALL PIPING THROUGH SLAB SHALL BE CUT AND CAPPED BELOW FLOOR. REFER TO ARCHITECTURAL DRAWINGS FOR PATCHING OF SLAB TO MATCH EXISTING.
- 7. ALL EXISTING BASE BUILDING UTILITIES, RISERS AND ALL SHAFTS SHALL REMAIN UNLESS OTHERWISE NOTED.
- 8. EXISTING RAIN WATER LINE TO EXISTING TANK SHALL REMAIN.
- LOCATION OF DRAINS AND PIPING ARE APPROXIMATE. CONTRACTOR WILL VERIFY IN
- 10. REMOVAL OF ALL EXISTING PIPING BEING ABANDONED SHALL COMPLY TO LOCAL AND STATE BUILDING CODE AS TO ELIMINATE THE POSSIBILITY OF FUTURE BREAKS AND UNNECESSARY INTERFERENCES IN HUNG CEILINGS.
- 11. WHERE EQUIPMENT OR PIPING IS TO BE REMOVED, CONTRACTOR SHALL REMOVE ALL COLLATERAL SUPPORTS, HANGERS AND APPURTENANCES.
- 12. CARE MUST BE TAKEN WHERE SLAB AND CEILINGS ARE TO BE DEMOLISHED TO PROTECT AND PROVIDE SUPPORT FOR ANY EXISTING EQUIPMENT OF PIPING WHICH IS TO REMAIN. (VERIFY IN FIELD)
- 13. ALL REMOVED ITEMS THAT ARE NOT BEING REUSED AND ALL EXCESS MATERIAL AND EQUIPMENT NOT DESIRED BY THE OWNER SHALL BE IMMEDIATELY MOVED FROM THE SITE BY THIS CONTRACTOR.
- 14. THE CONTRACTOR SHALL COORDINATE THE DEMOLITION WORK WITH THE OWNER AND OTHER TRADES.
- 15. PROTECT ALL EXISTING SOIL, WASTE, VENT AND WATER PIPES THAT ARE TO BE REUSED UPON COMPLETION OF DEMOLITION
- 16. CONTRACTOR SHALL PATCH AND REPAIR ALL FLOOR AND WALL OPENINGS TO MATCH EXISTING UPON COMPLETION OF PLUMBING DEMOLITION WORK.
- 17. ALL PLUMBING ROUGH INS WHICH ARE TO BE REMOVED MUST HAVE WATER SUPPLY SHUT OFF PRIOR TO DISCONNECTING AND REMOVING TO PREVENT FLOODING IN THE EVENT THAT PIPES ARE DAMAGED DURING DEMOLITION.
- 18. THE CONTRACTOR SHALL GIVE AMPLE WRITTEN NOTICE IN ADVANCE TO THE OWNER OF ANY REQUIRED SHUTDOWNS OF BUILDING SERVICES.

E. EQUIPMENT

- 1. INVESTIGATE PATH THROUGH WHICH EQUIPMENT WILL BE MOVED. ASCERTAIN FROM BUILDING MANAGEMENT WHAT TIMES OF DAY EQUIPMENT MAY BE MOVED.
- 2. ALL EQUIPMENT SHALL BE INSTALLED IN FULL COMPLIANCE WITH THE MANUFACTURER'S INSTALLATION INSTRUCTIONS.
- 3. INSTALL EQUIPMENT AS TO BE READILY ACCESSIBLE FOR OPERATION, MAINTENANCE AND REPAIR. MINOR DEVIATIONS FROM DRAWINGS MAY BE REQUIRED TO ACCOMPLISH THIS.

F. PIPING

1. EXISTING SANITARY / DOMESTIC PIPING TO BE CHECK & CONFIRM IF CAST IRON / GALVANIZED OR PVC. IF CAST IRON OR GALVANIZED, CHANGE TO PVC / CPVC. PIPING SYSTEMS SHALL BE CLEANED, PRESSURED / VACUUM / LEAK TESTED

- WHERE PIPING CONNECTIONS FOR FIXTURES DIFFER FROM THE LINE SIZE PIPING, IT SHALL BE RESPONSIBILITY OF THE PLUMBING CONTRACTOR TO FURNISH AND INSTALL THE NECESSARY REDUCER/EXPANDER FITTINGS TO ENABLE CONNECTION BETWEEN THE PIPING SYSTEM AND EQUIPMENT.
- 3. PROVIDE DIELECTRIC FITTINGS BETWEEN TWO DISSIMILAR METALS.
- WATER HAMMER ARRESTOR CONFORMED TO ASSE 1010 SHALL BE INSTALLED WHERE QUICK-CLOSING DEVICES ARE UTILIZED.
- WATER DISTRIBUTION PIPING AND FITTINGS SHALL CONFORM TO NSF 61 AND HAVE A PRESSURE RATING OF 150 PSI MINIMUM.
- 6. ALL VALVES SHALL BE OF AN APPROVED TYPE AND MATERIAL COMPATIBLE WITH THE SYSTEM PIPING TYPE. ALL VALVES INTENDED TO SUPPLY POTABLE WATER SHALL MEET THE REQUIREMENTS OF NSF 61.
- PVC PIPING SHALL NOT BE RUN THROUGH FIRE RATED WALLS OR USED IN RETURN AIR PLENUMS.
- CLEANOUTS SHALL BE PROVIDED AS REQUIRED BY APPLICABLE CODES. CLEANOUTS IN DRAINAGE LINES SHALL BE INSTALLED IN THE FOLLOWING LOCATIONS:
- AT THE BOTTOM OF EACH FIXTURE TRAP WHICH IS NOT INTEGRAL WITH THE
- AT THE END OF EACH BRANCH DRAINAGE LINE AT EACH POINT WHERE DRAINAGE LINES CHANGE DIRECTIONS
- AT THE FOOT OF EACH INSIDE RISING SOIL OR WASTE LINE
- IN EVERY HORIZONTAL LINE AT NOT MORE THAN FIFTY (50) FEET ON CENTER.
- 9. ALL HOT WATER SUPPLY & RETURN PIPING REQUIRES ¾" WALL ARM-A-FLEX
- 10. ALL PIPING SANITARY, WASTE, VENT, DOMESTIC HOT OR COLD THAT IS RUN THROUGH EXISTING TRANSFORMER AREAS, TO BE INSTALLED WITH FIREMASTER 3M

G. TESTING & COMMISSIONING

OR EQUIVALENT (FIRE RATED INSULATION).

- CONTRACTOR TO VERIFY OPERATING PRESSURES OF EXISTING DOMESTIC WATER SYSTEM.
- 2. PRESSURE TEST NEW DOMESTIC WATER PIPING (HOT WATER AND COLD WATER), AND SUBMIT PRESSURE TEST REPORT FOR THE ENGINEER'S RECORD. PRESSURE TEST SHALL BE PERFORMED AT 1.5 TIMES THE WORKING WATER PRESSURE FOR A PERIOD OF 3 HOURS MINIMUM.
- 3. TEST ALL WASTE, SANITARY AND VENT SYSTEMS WITH A MINIMUM OF TEN (10) FEET HEAD OF WATER. PIPING SHALL BE TIGHT AND LEAK FREE AT ALL
- 4. TEST ALL PIPING SYSTEMS VALVES FOR FULLY LEAK-TIGHT CLOSURE WHEN SUBJECTED TO NORMAL OPERATING PRESSURES.
- 5. ALL CONCEALED PIPING SHALL BE TESTED BEFORE CLOSING CEILING CONSTRUCTION.
- 6. TEST EQUIPMENT CONTROLS, INCLUDING HOT WATER HEATER CONTROLLER, LEAK ALARMS, AND VERIFICATION OF REMOTE CONTROL & MONITORING POINTS AT EXISTING BUILDING MANAGEMENT SYSTEM.
- 7. CONTRACTOR SHALL SUBMIT ALL START-UP, TESTING, AND COMMISSIONING REPORTS FOR THE ENGINEER'S REVIEW.

H. TAGS, CHARTS AND NAMEPLATES

- 1. CONTRACTOR SHALL PROPERLY IDENTIFY AND LABEL EACH VALVE, CONTROL, MOTOR, FAN AND PIECE OF APPARATUS IDENTIFIED ON THE PLUMBING
- EACH VALVE SHALL HAVE A BRASS TAG WITH IDENTIFYING NUMBER. TAG SHALL BE SECURED TO VALVE STEM WITH A SUFFICIENT LENGTH OF COPPER COATED JACK CHAIN TO ALLOW TAG TO BE EASILY READ. CONTRACTOR SHALL INCLUDE A VALVE IDENTIFICATION CHART IN THEIR SUBMITTAL PACKAGE.
- 3. ALL NAMEPLATES AND LABELS SHALL IDENTIFY COMPONENTS BY PROPER NOMENCLATURE AND NUMBERED ACCORDING TO THE EQUIPMENT

I. SUBMITTALS / SHOP DRAWINGS

- 1. THE CONTRACTOR SHALL SUBMIT SHOP DRAWINGS FOR THE FOLLOWING: 1.1. PIPIG FIXTURES, SUPPORTS AND TRIM
- 1.2. VALVES
- 1.3. PIPE INSULATION
- BACKFLOW PREVENTORS
- ELECTRIC CONTROLS WATER HAMMER ARRESTORS
- HANGERS AND SUPPORTS
- TRAP PRIMERS ACCESS DOORS AND CLEAN-OUT PLATES

PLUMBING DRAWING LIST				
DWG No. DESCRIPTION				
P-001	PLUMBING COVER PAGE			
P-400	PLUMBING SITE PLAN			
P-401	PLUMBING BELOW GRADE PLAN & SCHEDULE			

SYMBOLS & ABBREVIATIONS			
ABBREVIATIONS	ABBREVIATIONS DESCRIPTION		
\bowtie	BALL VALVE		
	ACTUATED BALL VALVE		
\bowtie	BACKWATER VALVE		
	PUMP		
NO.	NO. NUMBER		
PD	PRESSURE DROP		
PSI	POUNDS PER SQUARE INCH		
PSIG	PSI GAUGE		
(R)	RELOCATE		
N	NEW		



P.O. Box HM525 Hamilton HMCX Bermuda Phone: (441) 295-5151

DEPARTMENT OF WORKS AND ENGINEERING

Fax: (441) 295-5658



ENGINEERING SERVICES

ISSUED FOR: TENDER

25 Serpentine Road, Pembroke HM 07

Phone: (441) 294-3693

Email: info@iepc.bm www.iepc.bm

AMENDMENTS: NO | REVISION A FOR TENDER - 14/06/24

SCALE: AS SHOWN AT ANSI D

SURVEY DATE: PREPARED BY:

DESIGN DATE: PREPARED BY: D.CABRAL 22/07/24 CHECKED BY: DATE: 22/07/24

DRAWING PREPARED BY: DATE: 22/07/24 D.CABRAL DATE: CHECKED BY: 22/07/24 APPROVED BY: DATE:

PROJECT NUMBER: 09010030

PROJECT NAME:

2024

BOTANICAL GARDENS CACTI HOUSE MECHANICAL DESIGN

SHEET TITLE:

COVER PAGE

REVISION SHEET NUMBER: M100

Α

22/07/24

PLUMBING NOTES

A. BERMUDA DEPARTMENT OF PLANNING NOTES

- 1. ALL WORK SHALL COMPLY WITH APPLICABLE SECTIONS OF ALL LOCAL CODES AND AMENDMENTS TO DATE, INCLUDING BUT NOT LIMITED TO THE FOLLOWING:
 - a. BERMUDA BUILDING CODE 2014 (ADOPTED FROM IBC 2012)
 - b. BERMUDA MECHANICAL CODE 2014 (ADOPTED FROM IMC 2012)
 - c. BERMUDA ELECTRICAL CODE 2014 (ADOPTED FROM NEC 2011) d. BERMUDA PLUMBING CODE 2014 (ADOPTED FROM IPC 2012)
 - e. BERMUDA ENERGY CONSERVATION CODE 2014 (ADOPTED FROM IECC
- c. BERMUDA FIRE CODE 2014 (ADOPTED FROM NFPA STANDARDS)
- 2. ALL WORK SHALL COMPLY WITH THE REQUIREMENTS OF OF ALL APPLICABLE REFERENCE STANDARDS, INCLUDING BUT NOT LIMITED TO THE FOLLOWING: a. ANSI
- b. ASPE c. ASHRAE STANDARD 90.1: ENERGY STANDARD FOR BUILDINGS
- 3. ALL WORK SHALL BE SUBJECT TO SPECIAL INSPECTIONS AS APPLICABLE:
- a. WIND RESISTANCE (IBC SECTION 1705.10)
- b. SPRAYED FIRE-RESISTANT MATERIALS (IBC SECTION 1705.13) c. MASTIC AND INTUMESCENT FIRE RATED COATINGS (IBC SECTION
- 1705.14) d. FIRE RESISTANT PENETRATION AND JOINTS (IBC SECTION 1705.16)
- e. ENERGY CODE INSPECTIONS
- 4. ALL WORK SHALL COMPLY WITH THE GOVERNMENT OF BERMUDA LAWS AND REGULATIONS, INCLUDING BUT NOT LIMITED TO:
- a. BERMUDA PUBLIC HEALTH ACT 1949 b. BERMUDA OCCUPATIONAL SAFETY & HEALTH REGULATIONS 2009

B. OCCUPATIONAL HEALTH, SAFETY AND ENVIRONMENT (OHSE) REQUIREMENTS

- 5. THE CONTRACTOR SHALL PROVIDE DIRECT SUPERVISION OVER THEIR WORKFORCE ON SITE. AND ENSURE THEIR WORK CONFORMS TO OHSE POLICIES.
- 6. THE CONTRACTOR SHALL SUPPLY AND UTILIZE THE APPROPRIATE PERSONAL PROTECTION EQUIPMENT (PPE) FOR ALL WORKS.
- 7. THE CONTRACTOR SHALL OBTAIN ALL NECESSARY AND APPLICABLE PERMITS OR APPROVALS.
- 8. THE CONTRACTOR SHALL ELIMINATE OR CONTROL ALL SAFETY HAZARDS AND POTENTIAL ENVIRONMENTAL IMPACTS ASSOCIATED WITH THE PROJECT.

C. GENERAL NOTES

FRAMING.

- REMOVAL AND RELOCATION OF CERTAIN EXISTING WORK WILL BE NECESSARY FOR THE PERFORMANCE OF THE WORK. EXISTING CONDITIONS ARE NOT COMPLETELY DETAILED ON THE DRAWINGS. CONTRACTOR SHALL SURVEY THE SITE AND INCLUDE ALLOWANCE FOR SUCH REMOVALS AND RELOCATIONS.
- WORK SHALL BE DONE WHEN AND AS DIRECTED AND SHALL BE PERFORMED SO AS TO CAUSE THE LEAST POSSIBLE INCONVENIENCE AND DISTURBANCE TO THE SURROUNDING POPULATION, PLAN INSTALLATION OF NEW WORK AND CONNECTIONS TO EXISTING WORK TO AVOID INTERFERENCE WITH REGULAR OPERATION OF EXISTING FACILITIES.
- 3. MATERIALS. DOCUMENTATION AND WORKMANSHIP SHALL BE IN ACCORDANCE WITH LOCAL CODES. REFERENCE STANDARDS. AND AS SPECIFIED
- DISCONNECT, REMOVE AND/OR RELOCATE EXISTING MATERIALS, EQUIPMENT AND OTHER WORK AS NOTED OR REQUIRED FOR PROPER INSTALLATION OF NEW WORK.
- FIREPROOFING AND INSULATION DISTURBED BY NEW CONSTRUCTION SHALL BE RESTORED TO ORIGINAL CONDITION.
- SUPPORT ALL PIPING AND/OR EQUIPMENT FROM BUILDING STRUCTURE, FLOORS, AND BURIED IN TRENCH IN AN APPROVED MANNER. WHERE OVERHEAD CONSTRUCTION DOES NOT PERMIT FASTENING OF SUPPORTS FOR EQUIPMENT, FURNISH ADDITIONAL
- 7. SEAL OPENINGS AROUND PIPING THROUGH WALLS AND FOUNDATION SLABS IN AN APPROVED MANNER USING MINERAL WOOL OR OTHER NON-COMBUSTIBLE MATERIAL. ALL PENETRATIONS SHALL BE FIRE-PROOFED, AS REQUIRED.
- CONTRACTOR TO PROVIDE FULLY COORDINATED SHOP DRAWINGS AND SUBMITTALS FOR THE ENGINEER'S REVIEW PRIOR TO PROCUREMENT, FABRICATION, OR INSTALLATION OF NEW WORK.
- CONTRACTOR SHALL USE EXTREME CAUTION WHEN INSTALLING FIXTURES OR PIPING ON OR IN FINISHED WALLS AND PARTITIONS.
- 10. PROVIDE ANGLE STOPS ON WATER PIPING AT ALL FIXTURES.
- 11. CONTRACTOR SHALL VERIFY EXACT LOCATION OF EXISTING PIPING IN FIELD BEFORE ANY INSTALLATION OF NEW WORK.
- 12. FOR EXACT LOCATION OF PLUMBING FIXTURES, REFER TO ARCHITECTURAL
- 13. ALL PLUMBING WORK SHALL COMPLY WITH BUILDING STANDARDS AND
- REQUIREMENTS.
- 14. ALL NEW PLUMBING FIXTURES SHALL COMPLY WITH WATER CONSERVATION LAWS.
- 15. ALL FIXTURES SHALL BE AS SPECIFIED BY ARCHITECT, FURNISHED AND INSTALLED BY
- PLUMBING CONTRACTOR.
- 16. CONTRACTOR SHALL PROVIDE TRAP PRIMERS FOR ALL FLOOR DRAINS
- 17. CONTRACTOR SHALL PROVIDE ACCESS DOORS TO ALL DOMESTIC WATER VALVES AND TRAP PRIMERS.
- 18. CONTRACTOR SHALL PROVIDE WATER HAMMER ARRESTORS ON ALL QUICK CLOSING FIXTURES.
- 19. CONTRACTOR TO FIRE PROOF AND SEAL ALL PENETRATIONS THROUGH EXTERIOR WALLS IN AN APPROVED MANNER.

D. DEMOLITION

- 1. CONTRACTOR SHALL OBTAIN ALL REQUIRED PERMITS BEFORE ANY WORK IS BEGUN.
- 2. ALL EXITS SHALL BE KEPT READILY ACCESSIBLE AND UNOBSTRUCTED AT ALL TIMES.
- 3. ALL WASTE AND DEBRIS SHALL BE REMOVED IN APPROVED CONTAINERS ON A DAILY
- 4. ALL EXISTING PLUMBING FIXTURES NO LONGER IN USE SHALL BE REMOVED WITH ASSOCIATED PIPING. PLUG AND CAP AT SOURCE ALL UNUSED PIPING.
- 5. REMOVE UNUSED WASTE PIPING AND PATCH FLOOR PENETRATION AS REQUIRED.
- 6. ALL PIPING THROUGH SLAB SHALL BE CUT AND CAPPED BELOW FLOOR. REFER TO ARCHITECTURAL DRAWINGS FOR PATCHING OF SLAB TO MATCH EXISTING.
- 7. ALL EXISTING BASE BUILDING UTILITIES, RISERS AND ALL SHAFTS SHALL REMAIN UNLESS OTHERWISE NOTED.
- 8. EXISTING RAIN WATER LINE TO EXISTING TANK SHALL REMAIN.
- 9. LOCATION OF DRAINS AND PIPING ARE APPROXIMATE. CONTRACTOR WILL VERIFY IN FIELD.
- 10. REMOVAL OF ALL EXISTING PIPING BEING ABANDONED SHALL COMPLY TO LOCAL AND STATE BUILDING CODE AS TO ELIMINATE THE POSSIBILITY OF FUTURE BREAKS AND UNNECESSARY INTERFERENCES IN HUNG CEILINGS
- 11. WHERE EQUIPMENT OR PIPING IS TO BE REMOVED, CONTRACTOR SHALL REMOVE ALL COLLATERAL SUPPORTS, HANGERS AND APPURTENANCES.
- 12. CARE MUST BE TAKEN WHERE SLAB AND CEILINGS ARE TO BE DEMOLISHED TO PROTECT AND PROVIDE SUPPORT FOR ANY EXISTING EQUIPMENT OF PIPING WHICH IS TO REMAIN. (VERIFY IN FIELD)
- 13. ALL REMOVED ITEMS THAT ARE NOT BEING REUSED AND ALL EXCESS MATERIAL AND EQUIPMENT NOT DESIRED BY THE OWNER SHALL BE IMMEDIATELY MOVED FROM THE SITE BY THIS CONTRACTOR.
- 14. THE CONTRACTOR SHALL COORDINATE THE DEMOLITION WORK WITH THE OWNER AND OTHER TRADES.
- 15. PROTECT ALL EXISTING SOIL, WASTE, VENT AND WATER PIPES THAT ARE TO BE REUSED UPON COMPLETION OF DEMOLITION
- 16. CONTRACTOR SHALL PATCH AND REPAIR ALL FLOOR AND WALL OPENINGS TO MATCH EXISTING UPON COMPLETION OF PLUMBING DEMOLITION WORK.
- 17. ALL PLUMBING ROUGH INS WHICH ARE TO BE REMOVED MUST HAVE WATER SUPPLY SHUT OFF PRIOR TO DISCONNECTING AND REMOVING TO PREVENT FLOODING IN THE EVENT THAT PIPES ARE DAMAGED DURING DEMOLITION.
- 18. THE CONTRACTOR SHALL GIVE AMPLE WRITTEN NOTICE IN ADVANCE TO THE OWNER OF ANY REQUIRED SHUTDOWNS OF BUILDING SERVICES.

E. EQUIPMENT

- 1. INVESTIGATE PATH THROUGH WHICH EQUIPMENT WILL BE MOVED. ASCERTAIN FROM BUILDING MANAGEMENT WHAT TIMES OF DAY EQUIPMENT MAY BE MOVED.
- 2. ALL EQUIPMENT SHALL BE INSTALLED IN FULL COMPLIANCE WITH THE MANUFACTURER'S INSTALLATION INSTRUCTIONS.
- 3. INSTALL EQUIPMENT AS TO BE READILY ACCESSIBLE FOR OPERATION, MAINTENANCE AND REPAIR. MINOR DEVIATIONS FROM DRAWINGS MAY BE REQUIRED TO ACCOMPLISH THIS.

F. PIPING

- 1. PIPING SYSTEMS SHALL BE CLEANED, VACUUM / LEAK TESTED.
- 2. WHERE PIPING CONNECTIONS FOR FIXTURES DIFFER FROM THE LINE SIZE PIPING, IT SHALL BE RESPONSIBILITY OF THE PLUMBING CONTRACTOR TO FURNISH AND INSTALL THE NECESSARY REDUCER/EXPANDER FITTINGS TO ENABLE CONNECTION BETWEEN THE PIPING SYSTEM AND EQUIPMENT.
- 3. PROVIDE DIELECTRIC FITTINGS BETWEEN TWO DISSIMILAR METALS.
- 4. WATER HAMMER ARRESTOR CONFORMED TO ASSE 1010 SHALL BE INSTALLED WHERE QUICK-CLOSING DEVICES ARE UTILIZED.
- 5. WATER DISTRIBUTION PIPING AND FITTINGS SHALL CONFORM TO NSF 61 AND HAVE A PRESSURE RATING OF 150 PSI MINIMUM.
- 6. ALL VALVES SHALL BE OF AN APPROVED TYPE AND MATERIAL COMPATIBLE WITH THE SYSTEM PIPING TYPE. ALL VALVES INTENDED TO SUPPLY POTABLE WATER SHALL MEET THE REQUIREMENTS OF NSF 61.
- 7. PVC PIPING SHALL NOT BE RUN THROUGH FIRE RATED WALLS OR USED IN RETURN AIR PLENUMS.
- 8. CLEANOUTS SHALL BE PROVIDED AS REQUIRED BY APPLICABLE CODES. CLEANOUTS IN DRAINAGE LINES SHALL BE INSTALLED IN THE FOLLOWING LOCATIONS:
- AT THE BOTTOM OF EACH FIXTURE TRAP WHICH IS NOT INTEGRAL WITH THE
- AT THE END OF EACH BRANCH DRAINAGE LINE
- AT EACH POINT WHERE DRAINAGE LINES CHANGE DIRECTIONS AT THE FOOT OF EACH INSIDE RISING SOIL OR WASTE LINE
- IN EVERY HORIZONTAL LINE AT NOT MORE THAN FIFTY (50) FEET ON CENTER.

G. TESTING & COMMISSIONING

- 1. CONTRACTOR TO VERIFY OPERATING PRESSURES OF EXISTING DOMESTIC WATER SYSTEM.
- 2. GENERAL CONTRACTOR TO RETROACTIVELY COMMISSION EXISTING DOMESTIC WATER BOOSTER SYSTEM AND VERIFY AND ADJUST THE OPERATING PRESSURES OF THE SYSTEM.
- 3. PRESSURE TEST NEW DOMESTIC WATER PIPING (HOT WATER AND COLD WATER), AND SUBMIT PRESSURE TEST REPORT FOR THE ENGINEER'S RECORD.

- PRESSURE TEST SHALL BE PERFORMED AT 1.5 TIMES THE WORKING WATER PRESSURE FOR A PERIOD OF 3 HOURS MINIMUM.
- 4. TEST ALL WASTE, SANITARY AND VENT SYSTEMS WITH A MINIMUM OF TEN (10) FEET HEAD OF WATER. PIPING SHALL BE TIGHT AND LEAK FREE AT ALL POINTS.
- 5. TEST ALL PIPING SYSTEMS VALVES FOR FULLY LEAK-TIGHT CLOSURE WHEN SUBJECTED TO NORMAL OPERATING PRESSURES.
- 6. ALL CONCEALED PIPING SHALL BE TESTED BEFORE CLOSING CEILING CONSTRUCTION.
- 7. TEST EQUIPMENT CONTROLS, INCLUDING HOT WATER HEATER CONTROLLER, LEAK ALARMS, AND VERIFICATION OF REMOTE CONTROL & MONITORING POINTS AT EXISTING BUILDING MANAGEMENT SYSTEM.
- 8. CONTRACTOR SHALL SUBMIT ALL START-UP, TESTING, AND COMMISSIONING REPORTS FOR THE ENGINEER'S REVIEW.

H. TAGS, CHARTS AND NAMEPLATES

- 1. CONTRACTOR SHALL PROPERLY IDENTIFY AND LABEL EACH VALVE, CONTROL, MOTOR, FAN AND PIECE OF APPARATUS IDENTIFIED ON THE PLUMBING DRAWINGS.
- 2. EACH VALVE SHALL HAVE A BRASS TAG WITH IDENTIFYING NUMBER. TAG SHALL BE SECURED TO VALVE STEM WITH A SUFFICIENT LENGTH OF COPPER COATED JACK CHAIN TO ALLOW TAG TO BE EASILY READ. CONTRACTOR SHALL INCLUDE A VALVE IDENTIFICATION CHART IN THEIR SUBMITTAL PACKAGE.
- 3. ALL NAMEPLATES AND LABELS SHALL IDENTIFY COMPONENTS BY PROPER NOMENCLATURE AND NUMBERED ACCORDING TO THE EQUIPMENT SCHEDULES.

I. SUBMITTALS / SHOP DRAWINGS


- 1. THE CONTRACTOR SHALL SUBMIT SHOP DRAWINGS FOR THE FOLLOWING:
- 1.1. PLUMBING FIXTURES, SUPPORTS AND TRIM
- 1.2. VALVES
- 1.3. PIPE INSULATION
- 1.4. BACKFLOW PREVENTORS
- ELECTRIC WATER HEATERS AND CONTROLS
- 1.6. MIXING VALVES
- WATER HAMMER ARRESTORS HANGERS AND SUPPORTS
- 1.9. TRAP PRIMERS
- 1.10. ACCESS DOORS AND CLEAN-OUT PLATES

PLUMBING DRAWING LIST **DESCRIPTION** DWG No. PLUMBING COVER PAGE P - 001P - 400PLUMBING DRAWINGS

ABBREVIATIONS				
ABBREVIATIONS	DESCRIPTION			
CW	COLD WATER PIPING			
HW	HOT WATER PIPING			
HWH	HOT WATER HEATER			
(N)	NEW			
NO.	NO. NUMBER			
PD	PRESSURE DROP			
PSI	POUNDS PER SQUARE INCH			
PSIG	PSI GAUGE			
(R)	RELOCATE			
S	SANITARY PIPING			
SH	SHOWER			
SK	SINK			
V	VENT			
VB	VACUUM BREAKER			
VTR	VENT THRU ROOF			
W	WASTE PIPING			
WC	WATER CLOSET			

GUTTER DETAIL - NEW CACTI HOUSE PLUMBING LAYOUT

1:60

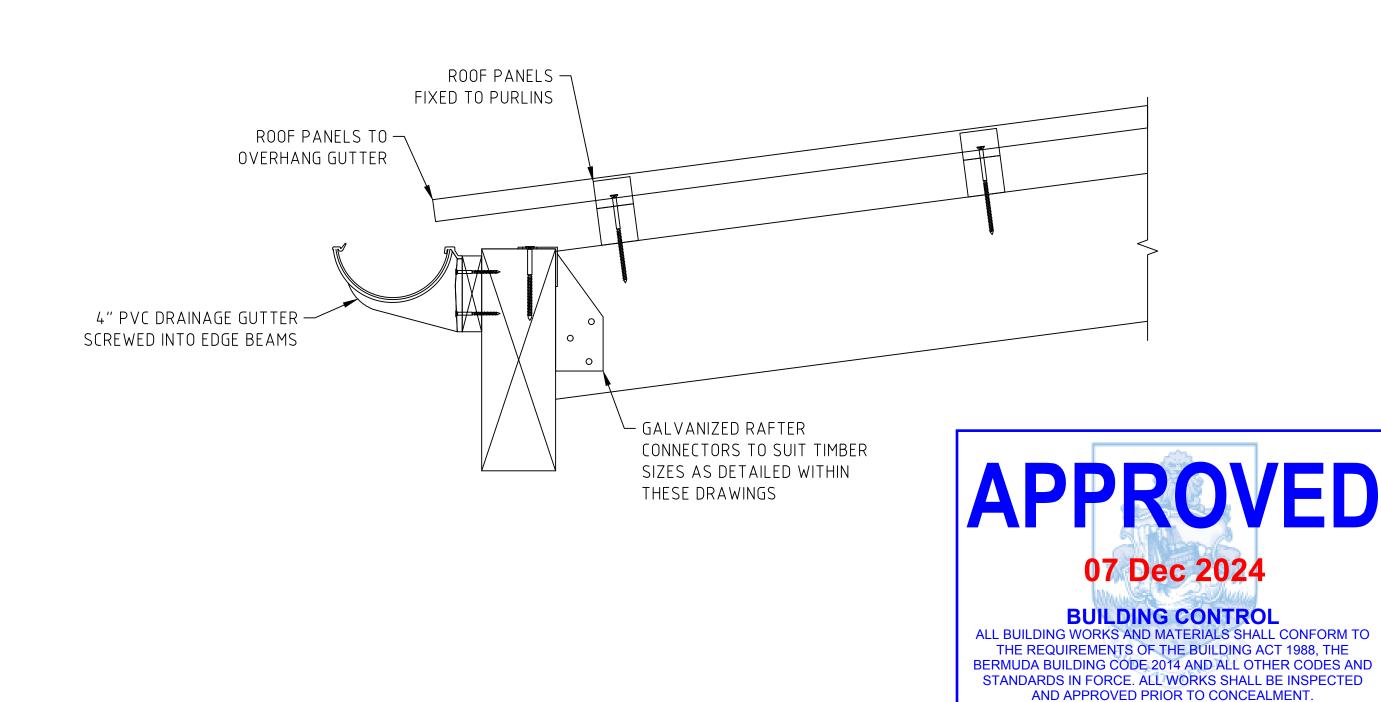

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DEPARTMENT OF WORKS AND ENGINEERING

Fax: (441) 295-5658

ENGINEER:



ENGINEERING SERVICES 25 Serpentine Road, Pembroke HM 07

Phone: (441) 294-3693 Email: info@iepc.bm www.iepc.bm

ISSUED FOR: TENDER

AMENDMENTS

NO | REVISION BY APPI DATE A SUBMITTED FOR REVIEW | CF | 14/06/24

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D.CABRAL

DRAWING PREPARED BY: D.CABRAL CHECKED BY:

PROJECT NUMBER:

APPROVED BY:

PROJECT NAME:

09010030

BOTANICAL GARDENS CACTI HOUSE MECHANICAL DESIGN

SHEET TITLE:

2024

PLUMBING NOTES & GUTTER DETAIL

SHEET NUMBER: M200

REVISION

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22/07/24


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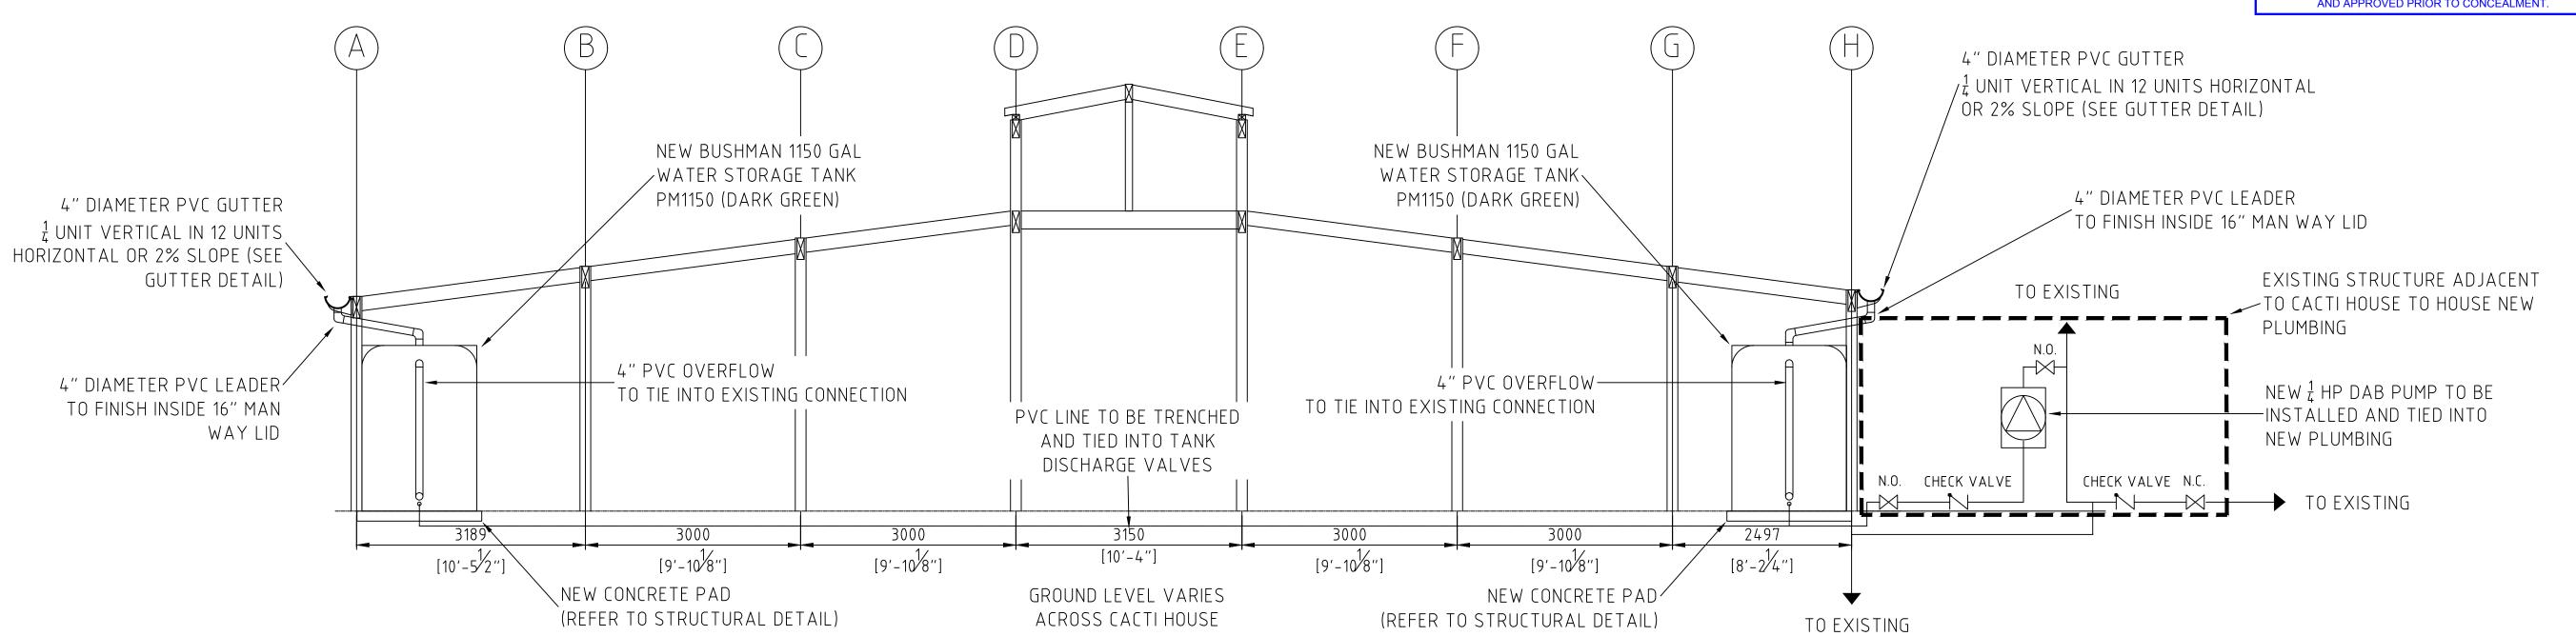
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NORTH PLAN VIEW - NEW CACTI HOUSE PLUMBING LAYOUT 1:50






WEST PLAN VIEW - NEW CACTI HOUSE PLUMBING LAYOUT

INTERIOR PLAN VIEW - NEW CACTI HOUSE PLUMBING LAYOUT

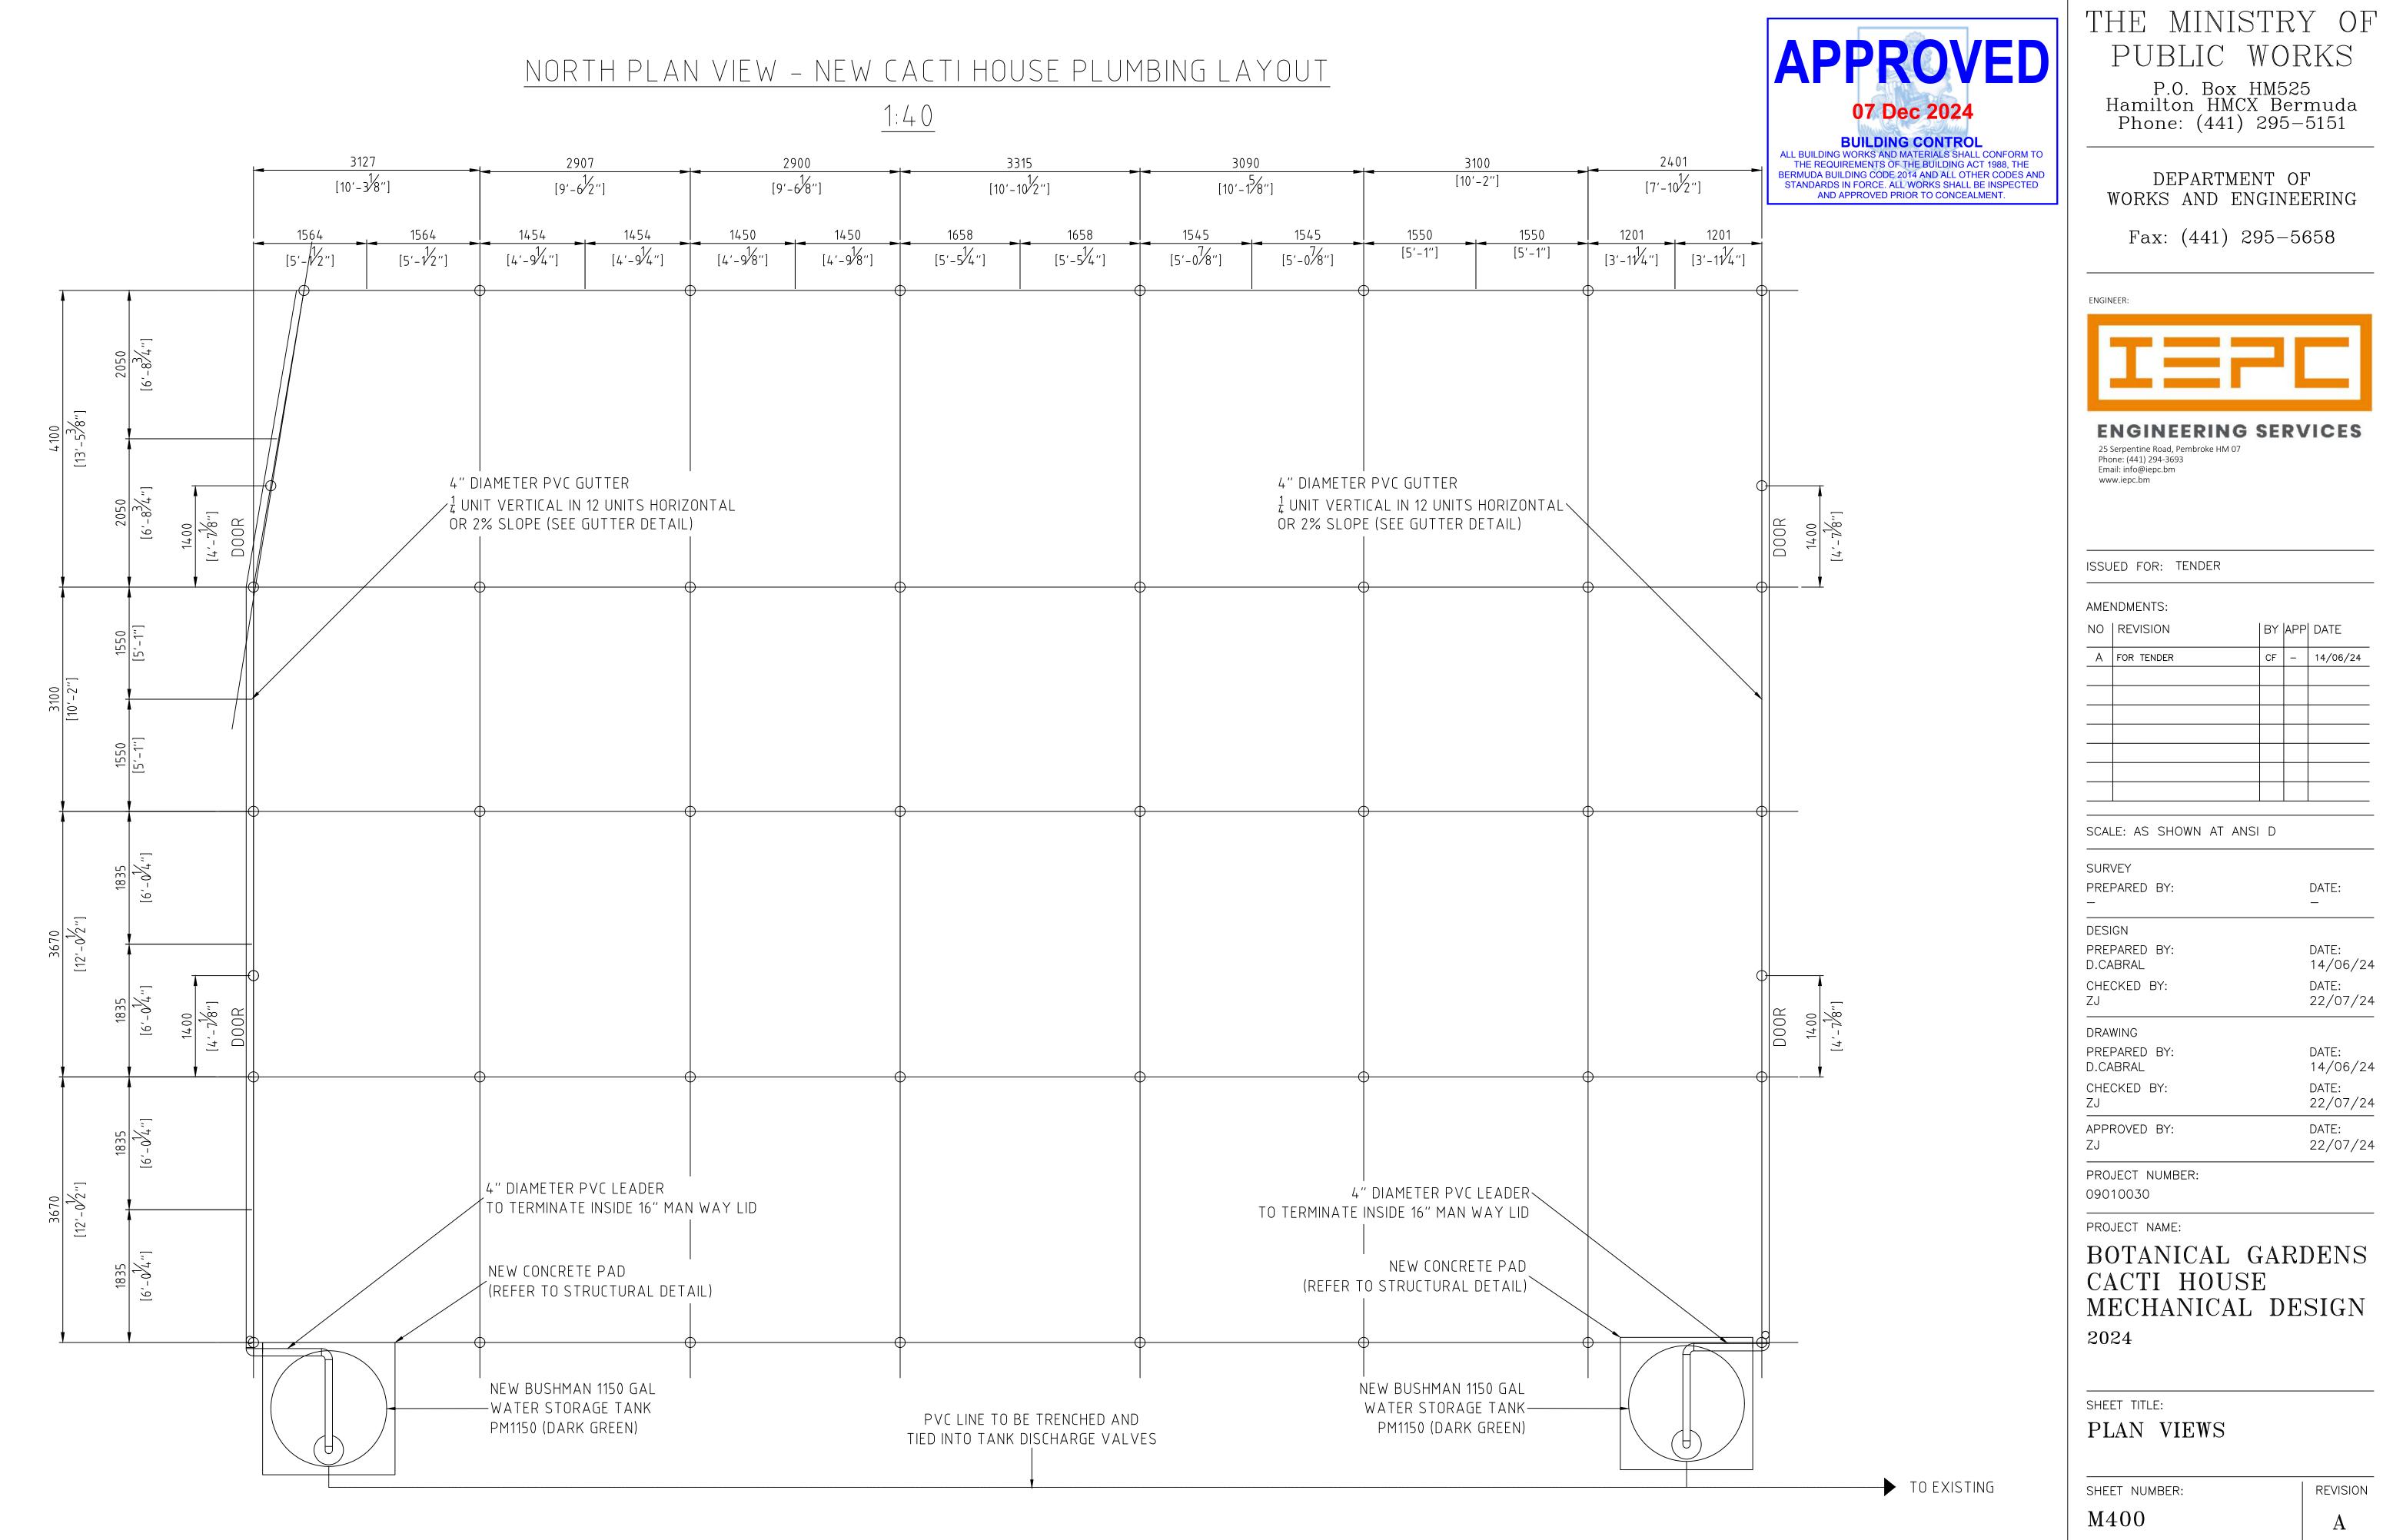1:75

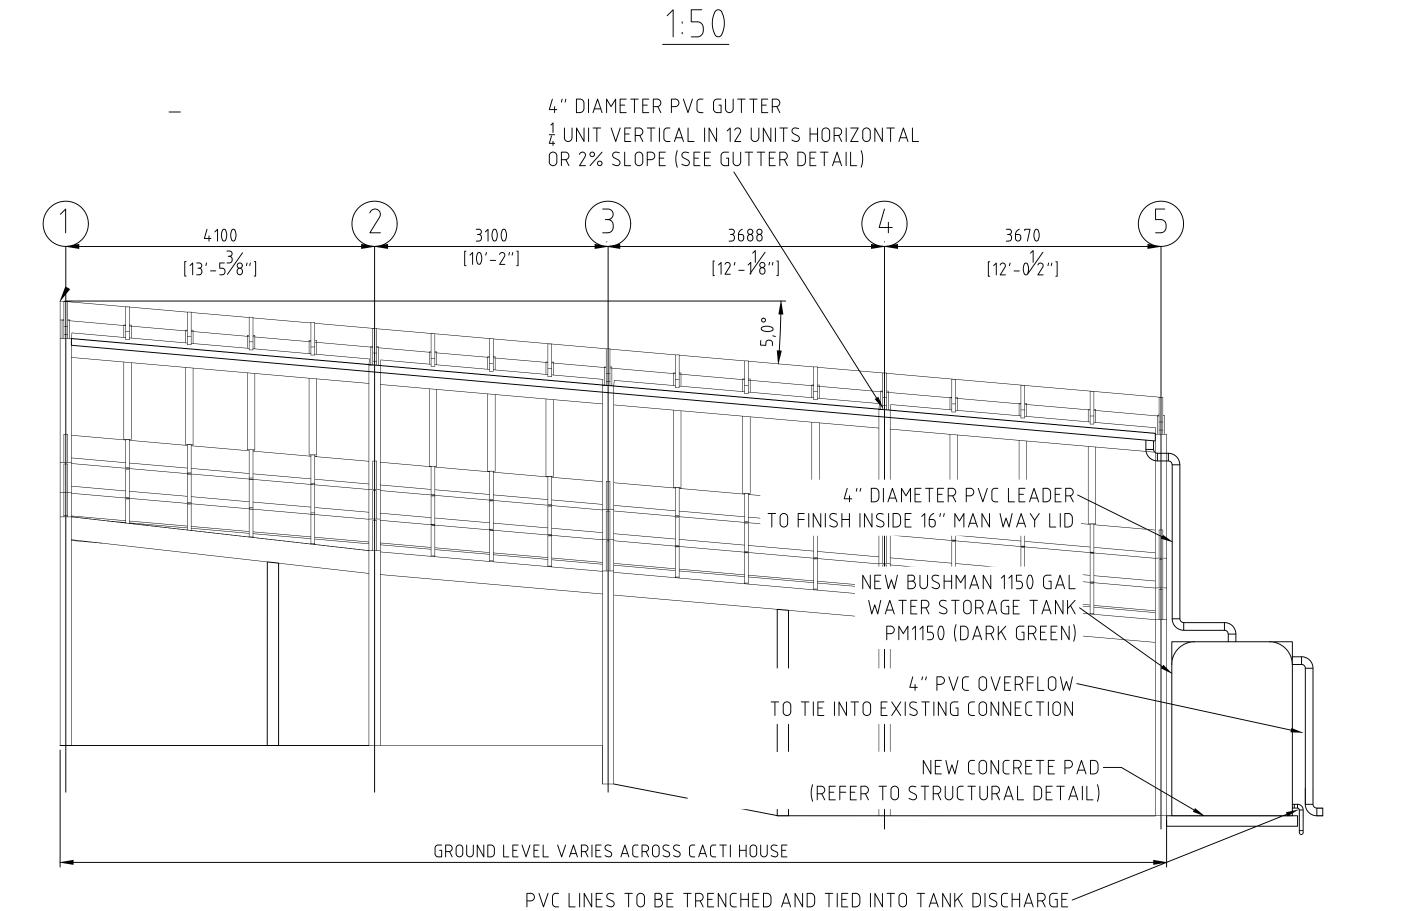

VALVES

 $\begin{array}{c|c}
 & [10'-5^{1/2}"] \\
 & 692 & 2497 \\
 & [2'-3^{1/4}"] & [8'-2^{1/4}"]
\end{array}$ /EXISTING WATER BIB LOCATION WB EXISTING WATER BIB LOCATION LOCATION OF NEW WALL-MOUNTED HOSE REAL STORAGE UNIT EXISTING WATER BIB LOCATION LOCATION OF NEW WALL-MOUNTED HOSE REAL STORAGE UNIT

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CHECKED BY: APPROVED BY:

PROJECT NUMBER: 09010030

PROJECT NAME:

BOTANICAL GARDENS CACTI HOUSE MECHANICAL DESIGN

2024

SHEET TITLE: PLAN VIEWS

REVISION SHEET NUMBER: M401 \mathbf{A}

ELECTRICAL SPECIFICATIONS

- 1, THE ELECTRICAL INSTALLATION SHALL BE IN COMPLIANE WITH THE REQUIREMENTS OF THE LATEST EDITIONS OF NFPA 70 (ELECTRICAL CODE), NEPA 72 (FIRE ALRM CODE), AND NEPA 101 (LIFE SAFETY CODE).
- 2: WIRING SHALL COMPL' WITH NFPA 70, WHICH INCLUDE: THE INSTALL OF NEW WIRING TO ELECTRIC VEHICLE SHELTER ELEICTRICAL DEVICES.
- 3. CONTRACTOR SHALL ALLOW FOR VOLTAGE DROPS TO INSURE PROPER VOLTAGE AT ELE CTRICAL DEVICES.
- ALL WIRING SHALL BE NEW, HOWEVER THE RE-USE OF EXISTING WIRING SHALL BE ALLOWED BUT SHALL BE INSPECTED BEFORE INSTALLATION BY ENGINEER OF RECORD.
- 5. ANY DISCREPANCIES BETWEEN DRAWINGS AND/OR SPECIFICATIONS AND EXISTING CONDITIONS, MUST BE REFERRED TO THE ENGINEER BEFORE ANY WORK IS BEGUN.
- 8. CONTRACTOR SHALL ENSURE PROPER COORDINATION WITH ELECTRICAL ENGINEER AS REQUIRED. CONTRACTOR SHALL ALSO COORDINATE WITH PROJECT MANAGER IN LAYING OUT OF WORK SO AS NOT TO CONFLICT WITH WORK OF OTHER TRADES. LASTLY, CONTRACTOR SHALL CARRY OUT WORK AS PER CONSTRUCTION SCHEDULE.
- 7. WORK IN REFERENCE 'O AUTOMATIC TRANSFER SWITCH SHALL ME IN COMPLIANCE WITH THE REQUIREMENTS OF NFPA 70 (ARTICLE 700.
- 8. THE PARALLEL GENERATORS SHALL BE IN COMPLIANCEWITH THE REQUIREMENTS OF NFPA 70 ARTICLE 445 AND ARTICLE 7/05.
- 9. ALL WORK SHALL COMILY WITH THE BERMUDA DEPARTMENT OF PLANNING NOTES.
- 10. ALL WORK SHALL COPPLY WITH APPLICABLE SECTION: OF ALL LAWS, LOCAL CODES AND AMENDMENTS TO DATE, INCLUDING

- 10.1. BERINJOA BUILDING CODE 2014 (ADOPTED FROM BC 2012)
 10.2. BERINJOA MECHANICAL CODE 2011 (ADOPTED FROM MC 2012)
 10.3. BERINJOA FREE CODE 2011 BERINJOA FREE STAFETY ICT 2014 (ADOPTED FROM NFPA STANDARDS)
 10.4. BERINJOA ELECTRICAL CODE 2014 (ADOPTED FROM MC 2011)
 10.5. BERINJOA ENERGY CONSERVATION CODE 2014 (ADOPTED FROM BC 2012)

- 11. ALL WORK SHALL COIPLY WITH THE REQUIREMENTS (F OF ALL APPLICABLE REFERENCE STANDARDS, INCLUDING:
- 11.1. ASHRAE HANDBOOKS

- 11.1. Nepha 3: LAMMABIE AND COMBUSTBLE LIQUIDS COCE
 11.3. Nepha 3: ETANDARN FOR THE INSTALLATION OF OIL-BURNING EQUIPMENT
 11.4. NEPA 3: STANDARN FOR THE INSTALLATION OF OIL-BURNING EQUIPMENT
 11.4. NEPA 3: STANDARN FOR THE INSTALLATION AND UE OF STATIONARY COMBUSTION ENGINES AND GAS TURBINES
 11.5. NEPA 70: NATIONALELECTRIC COCE
- 11.6. NFPA 72: NATIONAL FIRE ALARM AND SIGNALING CODE, 2019
- 117. NFPA 101: LIFE SAFETY CODE 11.8. NFPA 110: STANDARD FOR EMERGENCY AND STANDBY POWER SYSTEMS

DRAWING INDEX

95	DRAWING NUMBER	BAYMING TITLE DRAWING TITLE	ISSUE DATES			_	
SHEET NUMBER			ISSUED FOR PERMIT 09.13.2024				100
1	E-000	ELECTRICAL COVER PAGE					
2	E-001	EXISTING POWER SUPPLY			- 0		
3	E-002	EXISTING ELECTRICAL ROOM LAYOUT					Г
4	E-003	PROPOSED ELECTRICAL ROOM LAYOUT	•	0.00			
5	E-004	REFLECTED CEILING PLAN (LIGHTING FAN, POWER)		100			Г
6	E-005	FIRE ALARM LAYOUT					
					-	-	-
		1			-		

KEY OF SYMBOLS

DUPLEX RECEPTACLE		AUTOMATIC TRANSFER SWITCH
QUAD RECEPTACLE		ELECTRICAL PANEL
GROUND FAULT (GFC) RECEPTACLE	14	METER
FLOOR SURFACE MOINTED DUPLEX RECEPTACLE	www.	ELECTRICAL SWITCHGEAR
TELEPHONE OUTLET -WALL MOUNTED	⊡o	FIRE ALARM BELL
DATA OUTLET - WALL YOUNTED	0	SMOKE DETECTOR
TELEPHONE/DATA OUTLET - FLOOR MOUNTED	0	HEAT DETECTOR
ELECTRICAL PANEL	PS	PULL STATION
SURFACE MOUNTED LED LIGHT	SL	STROBE LIGHT
120/208-240V LED HIGH BAY INDUSTRIAL LIGHT W/MOTION SENSOR	•	HORN STROBE
DISCONNECT	-	CONDUIT RUN
SECURITY CAMERA	ı	JUNCTION BOX
OUTDOOR WEATHERPROOF LED LIGHT	E4	REMOTE ANNUNCIATOR
EMERGENCY LIGHT WITH BATTERY BACK-UP	E	EXISTING
2-WAY LIGHT SWITCH	⊠ -	DIRECT CONNECTION
3-WAY LIGHT SWITCH	□	THERMOSTAT

ELECTRICAL NOTES

1. LIGHTING NOTES

1.1. GENERATOR INSTALLATON SHALL COMPLY WITH THE LABST EDITION OF NFPA 78 NATIONAL ELECTRICAL CODE.



BUILDING CONTROL
ALL BUILDING WORKS AND MATERIALS SHALL CONFORM TO
THE REQUIREMENTS OF THE BUILDING ACT 1988, THE BERMUDA BUILDING CODE 2014 AND ALL OTHER CODES AND STANDARDS IN FORCE, ALL WORKS SHALL BE INSPECTED AND APPROVED PRIOR TO CONCEALMENT.

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CACTI HOUSE REDEVELOPMENT PROJECT 2024

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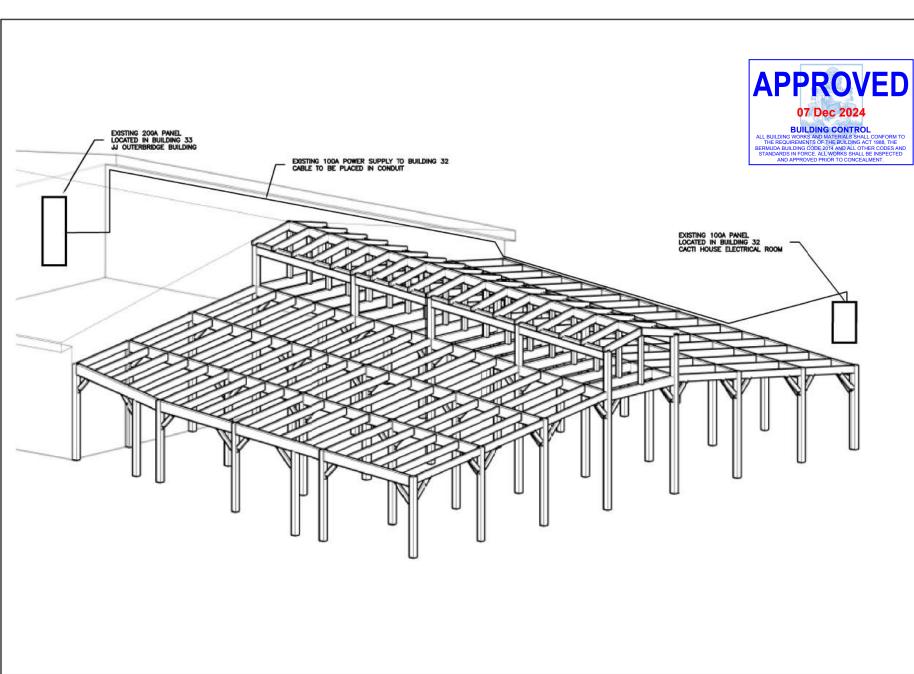
ELECTRICAL SPECIFICATIONS

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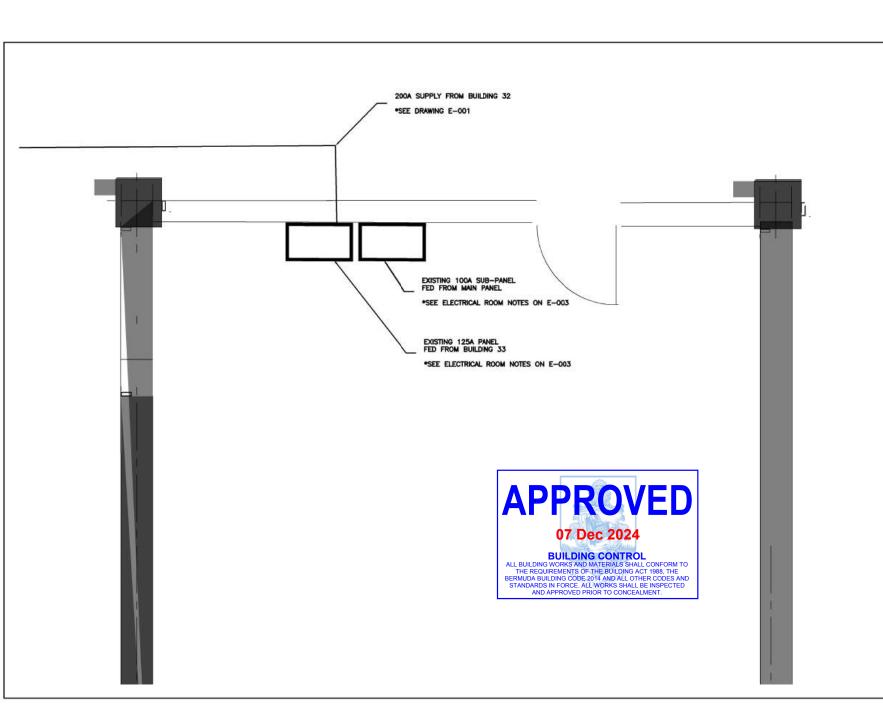
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PROJECT NAME:

CACTI HOUSE REDEVELOPMENT PROJECT 2024

EXISTING POWER SUPPLY

SHEET NUMBER: REVISION D



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PREPARED BY: JAMAR DILL CHECKED BY:

APPROVED BY: JAMAR DILL

PROJECT NUMBER: 09010030

PROJECT NAME:

CACTI HOUSE REDEVELOPMENT PROJECT 2024

SHEET TITLE

CACTI HOUSE ELECTRICAL ROOM

SHEET NUMBER: REVISION L-001 0





ELECTRICAL ROOM NOTES:

- 1. ELECTRICAL PANEL NOTES:
- ELECTRICAL PANELS SHOWN ABOVE TO BE REPLACED WITH ONE NEW 42 CIRCUIT 1.1. 200A PANEL.
- 1.2. NEW 42 CIRCUIT PANEL WILL FEED A 100A DISCONNECT TO BE USED TO SUPPLY TEMPORARY FEED USED FOR AGRICULTURAL EXHIBITION.
- 2. ELECTRICAL ROOM NOTES:
 - NEW POWER SUPPLY TO OUTDOOR PUMP IS REQUIRED. TO BE COORDINATED ON SITE WITH ENGINEER.
- 2.2. EXISTING RECEPTACLES TO BE REPLACED WITH GFI'S.
- 2.3. FEED TO NEW PANEL TO BE INSTALLED IN CONDUIT. TO BE COORDINATED ON SITE

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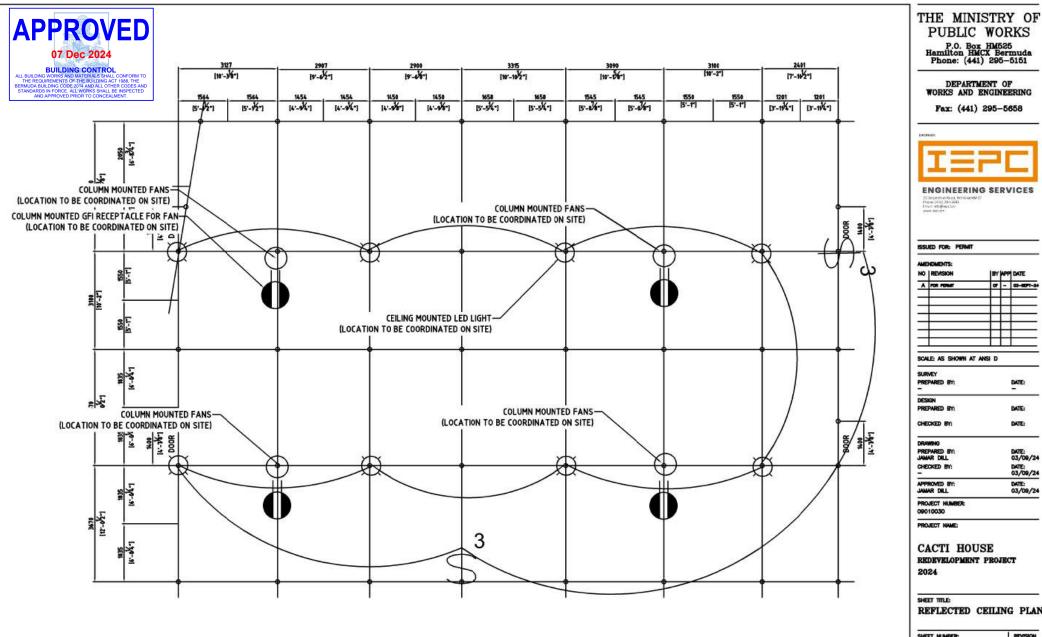
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CACTI HOUSE REDEVELOPMENT PROJECT 2024

ELECTRICAL ROOM LAYOUT

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PUBLIC WORKS




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JAMAR DILL	03/09/24

REDEVELOPMENT PROJECT

REFLECTED CEILING PLAN

HEET NUMBER:	REVISION
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REDEVELOPMENT PROJECT

FIRE ALARM LAYOUT

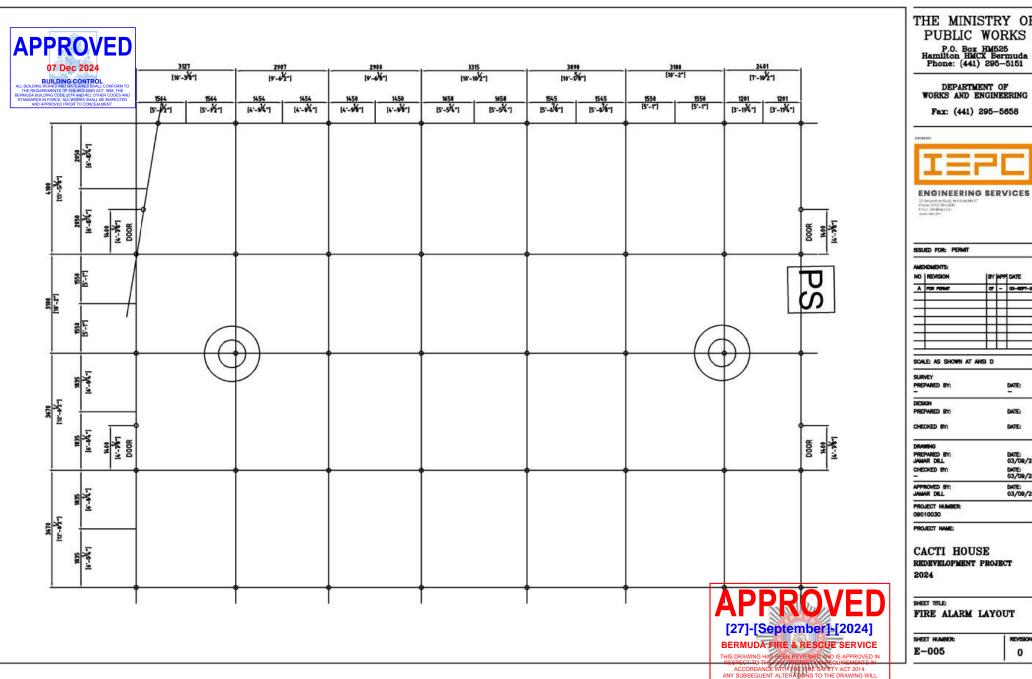REVISION 0

By: Anthrun O'Brien Rank: A/Sgt Ref: 16/291(b) Note: This stamped approved only with the condition that horn/strobe devices will be installed.