

- GENERAL NOTES:
1. SURVEY GRID IS BNG2000
2. LEVELS ARE IN METERS
ABOVE ORDINANCE DATUM
3.


WHITE'S ISLAND QUAY REPAIRS

61-74-120

2025



SITE PLAN
1:500

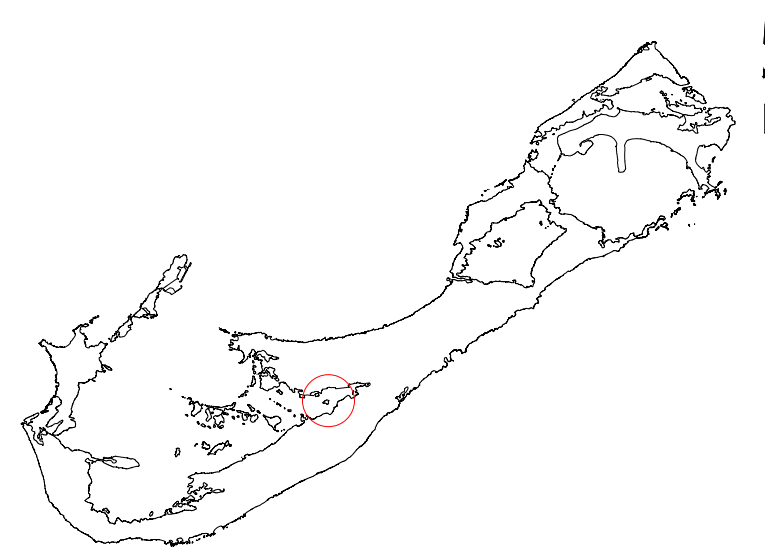

LOCATION PLAN
N.T.S.

ISSUED FOR: INFORMATION

AMENDMENTS:		
NO:	REVISION	DATE:
A	FOR TENDER	12/03/25

SCALE: AS SHOWN AT ANSI D

SURVEY	
PREPARED: -	DATE: -
DESIGN	
PREPARED: A.KENNY	DATE: 12/03/2025
CHECKED: -	DATE: -
DRAWING	
PREPARED: A.KENNY	DATE: 12/03/2025
CHECKED: -	DATE: -

APPROVED BY:
A.KENNY


PROJECT NUMBER:
61-74-120

PROJECT NAME:
**WHITE'S ISLAND
DOCK REMEDIATION**




WHITE'S ISLAND, PAGET

SHEET TITLE:
TITLE PAGE

SHEET NUMBER: S001	REVISION A
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- GENERAL NOTES:
1. SURVEY GRID IS BNG2000
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AMENDMENTS:		
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A	FOR TENDER	12/03/25

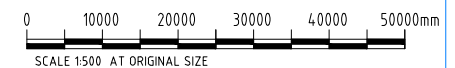SCALE: AS SHOWN AT ANSI D

SURVEY
PREPARED: - DATE: -

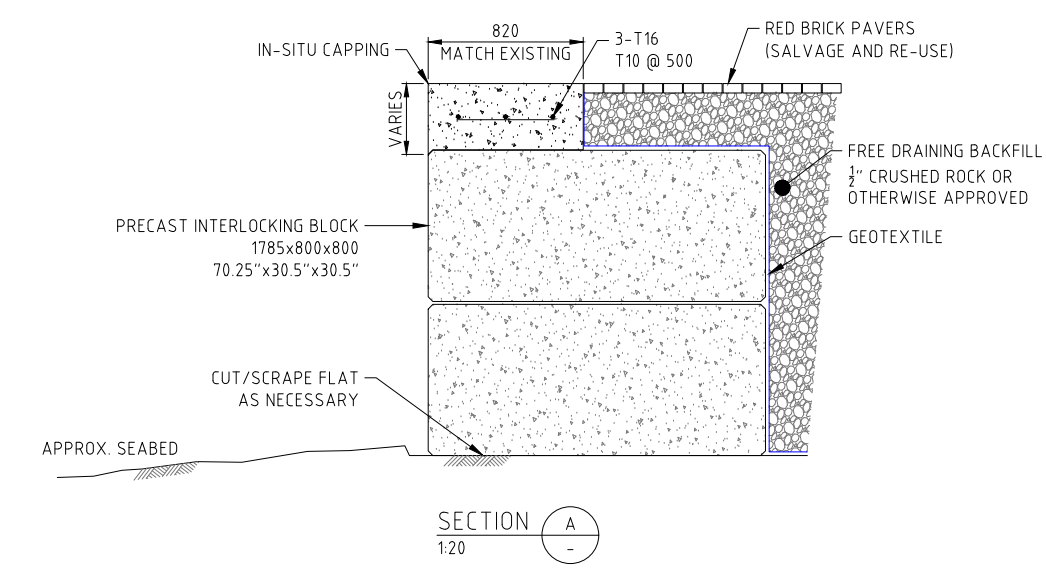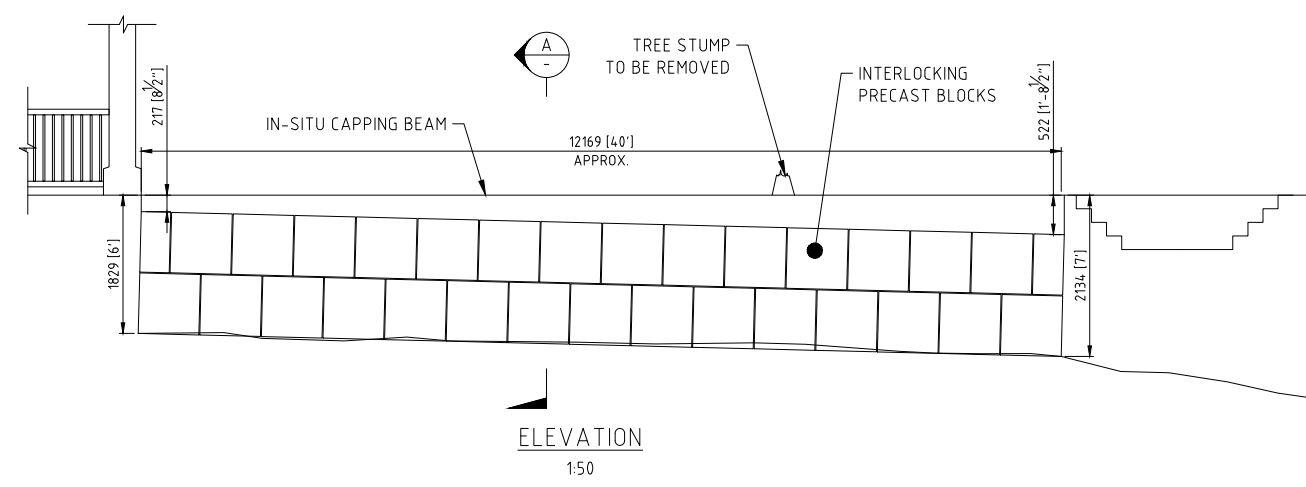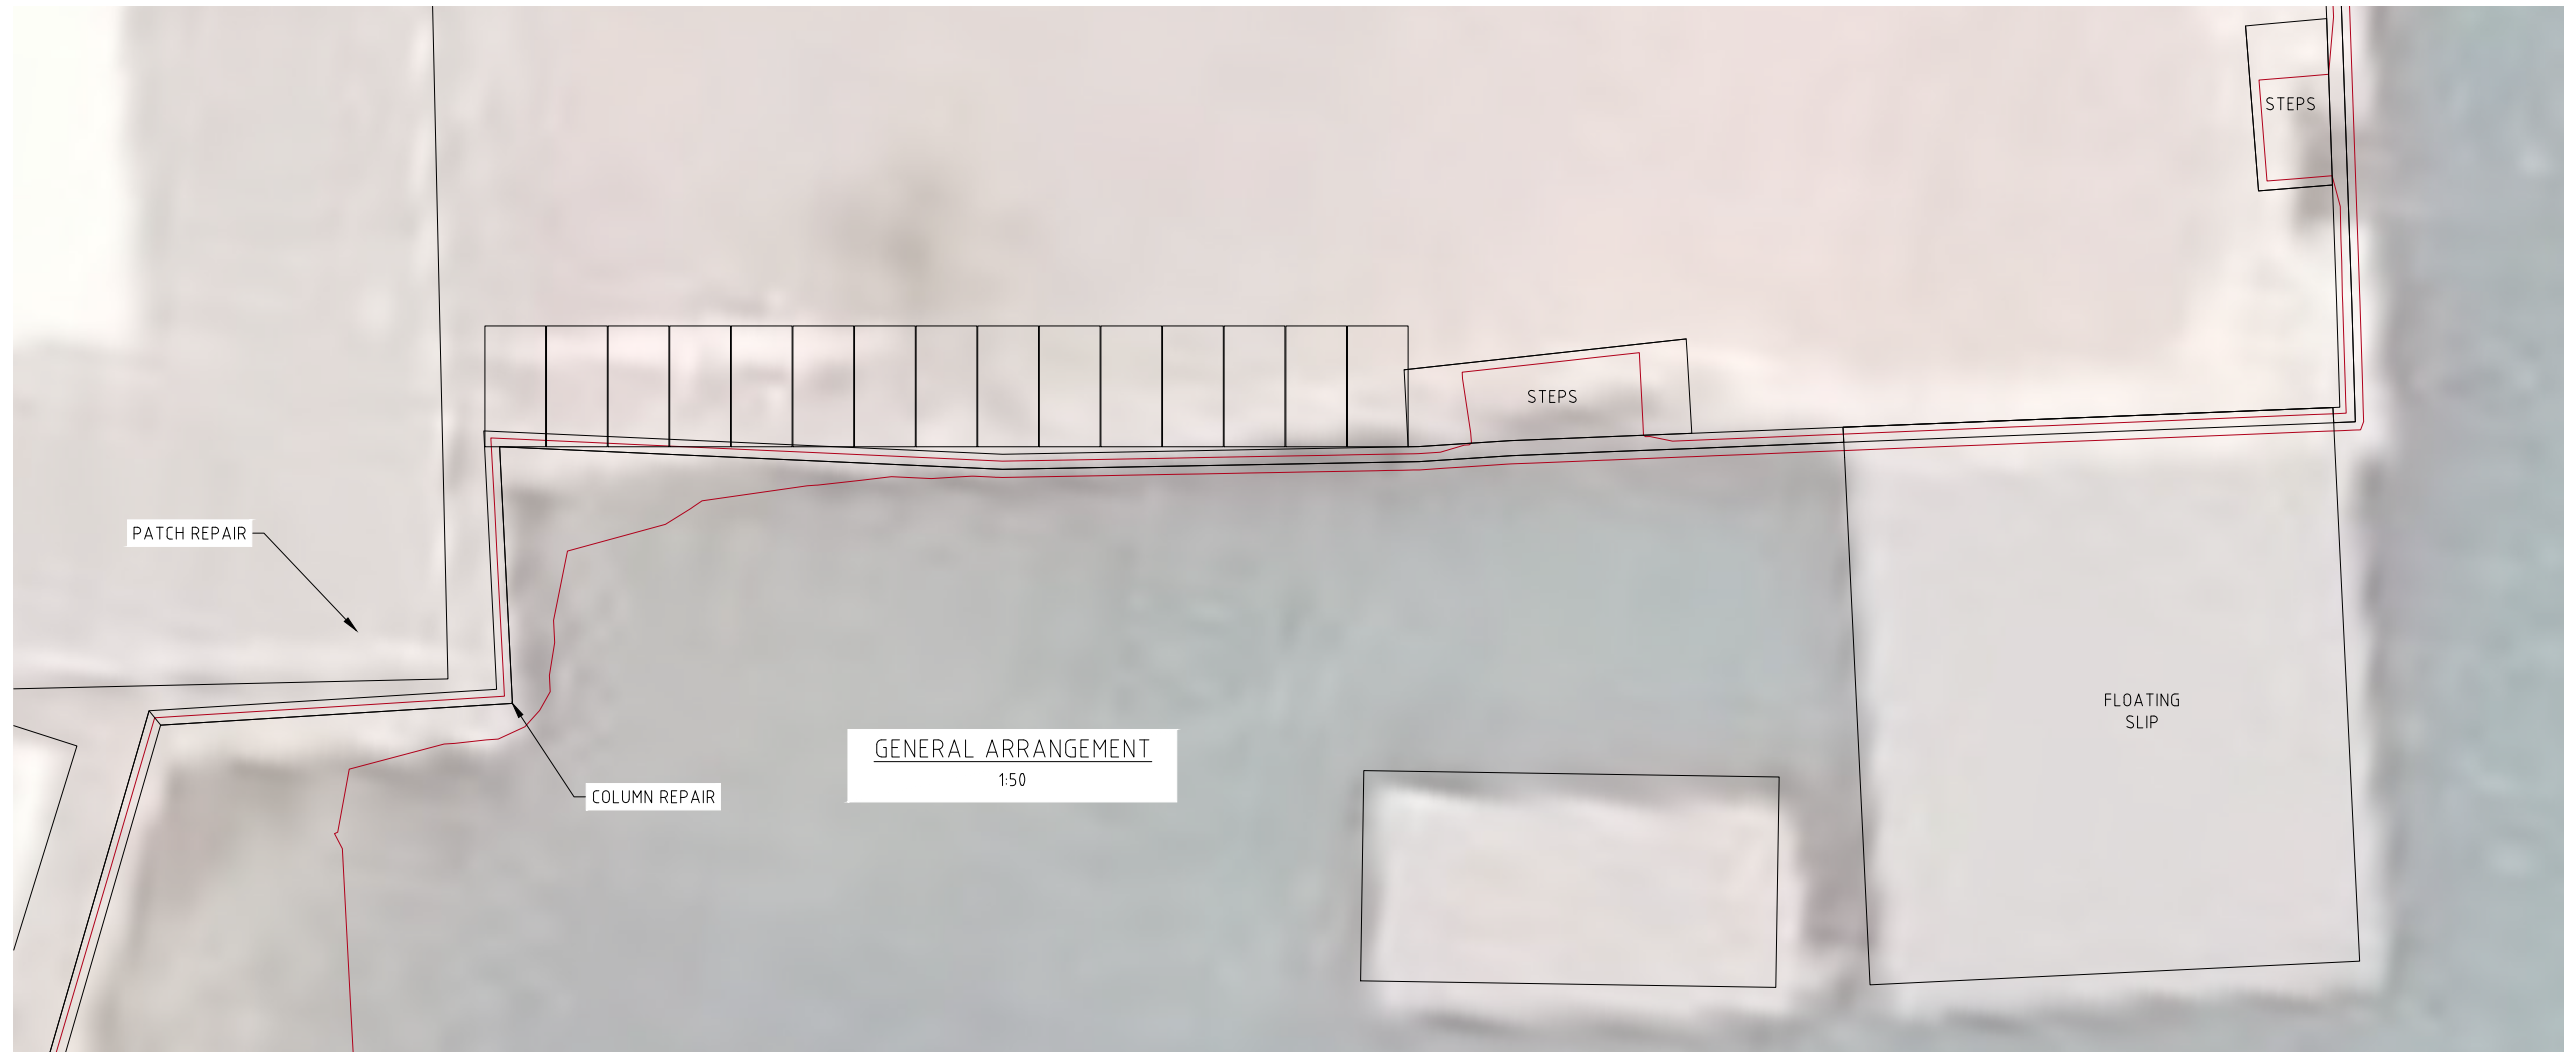DESIGN
PREPARED: A.KENNY DATE: 12/03/2025
CHECKED: - DATE: -

DRAWING
PREPARED: A.KENNY DATE: 12/03/2025
CHECKED: - DATE: -


APPROVED BY:
A.KENNY

PROJECT NUMBER:
61-74-120

PROJECT NAME:
**WHITE'S ISLAND
DOCK REMEDIATION**

WHITE'S ISLAND, PAGET
SHEET TITLE:
**DOCK WALL
RE-CONSTRUCTION**
SHEET NUMBER:
S002

REVISION
A

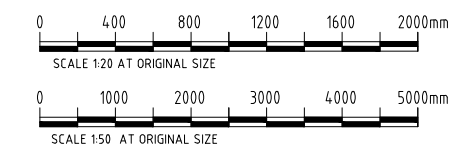

GENERAL NOTES:
1. SURVEY GRID IS BNG2000
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CONCRETE CRACK/PATCH REPAIR:


1. SAWCUT EDGE OF AREA MIN ½" DEEP
2. BREAKOUT TO SOUND CONCRETE
3. PREPARE SUBSTRATE BY EXPOSING AGGREGATE SURFACES (HIGH PRESSURE WATER OR SCABBLER)
4. REMOVE ALL DIRT, OIL, GREASE ETC FROM AREA TO BE REPAIRED
5. CLEAN EXPOSED STEEL
6. PRIME SUBSTRATE
7. APPLY PRODUCT, SCRUBBING INTO SUBSTRATE, FORCING INTO EDGES AND WORKING TOWARDS CENTER
8. ALLOW PRODUCT TO STIFFEN, FINISH WITH SPONGE FLOAT

CONCRETE COLUMN REPAIR:


1. SAWCUT EDGE OF AREA MIN. 1" DEEP
2. BREAKOUT TO SOUND CONCRETE
3. PREPARE SUBSTRATE BY EXPOSING AGGREGATE SURFACES (HIGH PRESSURE WATER OR SCABBLER)
4. REMOVE ALL DIRT, OIL, GREASE ETC FROM AREA TO BE REPAIRED
5. CLEAN EXPOSED STEEL
6. PRIME SUBSTRATE
7. SHUTTER AND POUR 3000psi CONCRETE TO MATCH ORIGINAL LINES
8. REMOVE FORMS AFTER MIN. 7 DAYS

CONCRETE SLAB REPAIR:


1. SAWCUT EDGE OF AREA FULL DEPTH
2. REMOVE AND DISPOSE SLAB, EXCAVATE ORGANIC FILL
3. BACKFILL WITH CLEAN CRUSHED ROCK, COMPACTED
4. TOP WITH 2" BEDDING SAND, COMPACTED
5. ISOLATE PERIMETER WITH STIFF JOINT
6. POUR NEW 6" SLAB WITH A143 MESH, CENTRAL
7. BROOM FINISH

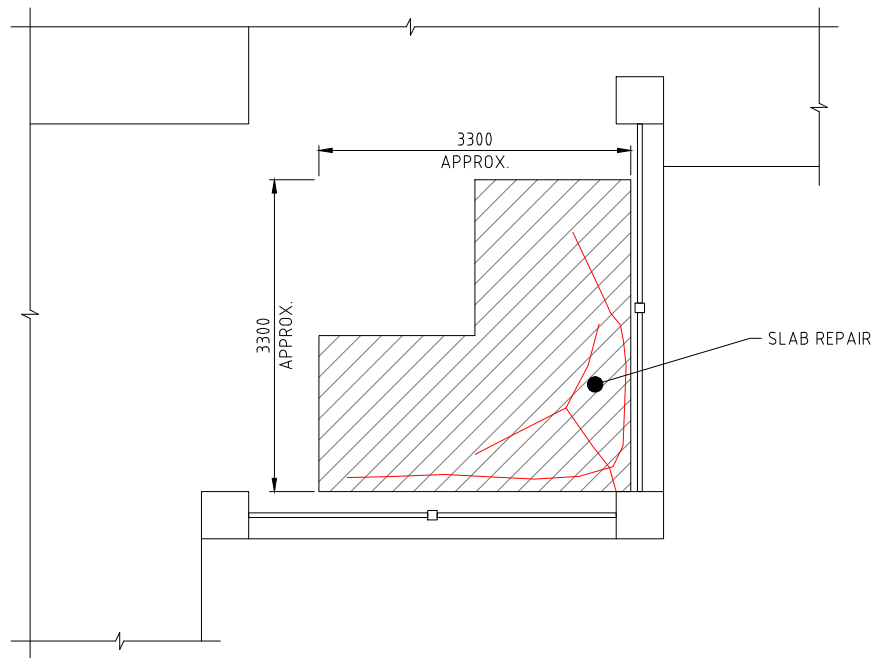

PLAN
1:40

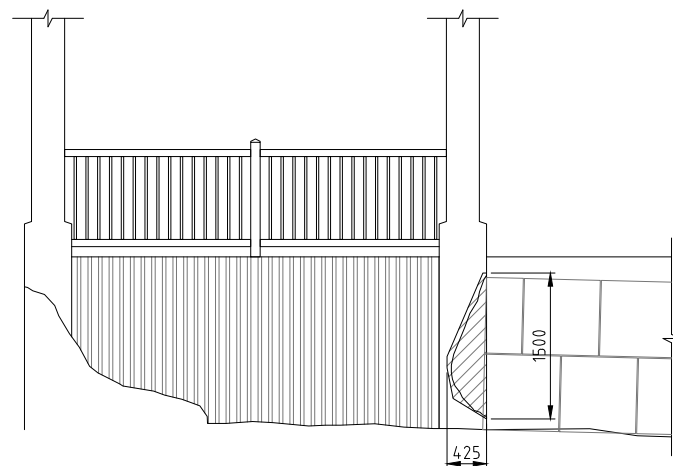

SOUTH ELEVATION
1:40

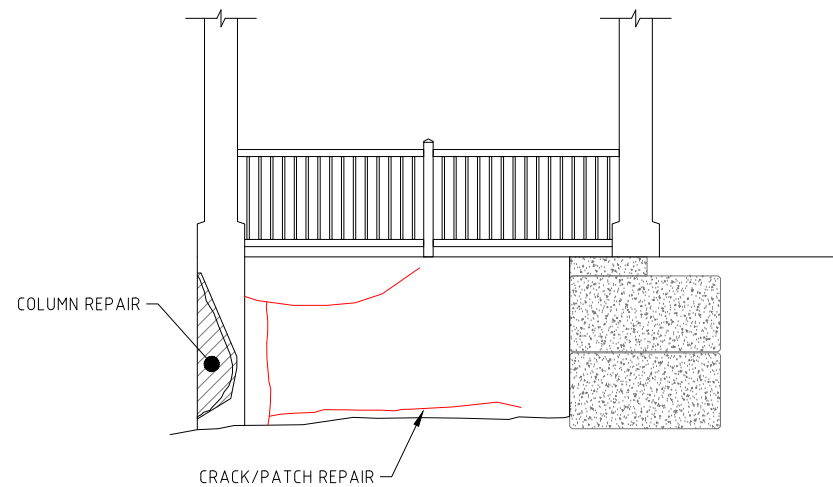

EAST ELEVATION
1:40

ISSUED FOR: INFORMATION		
AMENDMENTS:		
NO:	REVISION	DATE:
A	FOR CONSTRUCTION	26/04/24

SCALE: AS SHOWN AT ANSI D
 SURVEY
 PREPARED: - DATE: -
 DESIGN
 PREPARED: A.KENNY DATE: 12/03/2025
 CHECKED: - DATE: -
 DRAWING
 PREPARED: A.KENNY DATE: 12/03/2025
 CHECKED: - DATE: -
 APPROVED BY:
 A.KENNY
 PROJECT NUMBER:
 61-74-120

PROJECT NAME:
**WHITE'S ISLAND
DOCK REMEDIATION**


WHITE'S ISLAND, PAGET
 SHEET TITLE:
ADDITIONAL REPAIRS

SHEET NUMBER:
S003


REVISION
A




- GENERAL NOTES:
1. SURVEY GRID IS BNG2000
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ABOVE ORDINANCE DATUM
3.

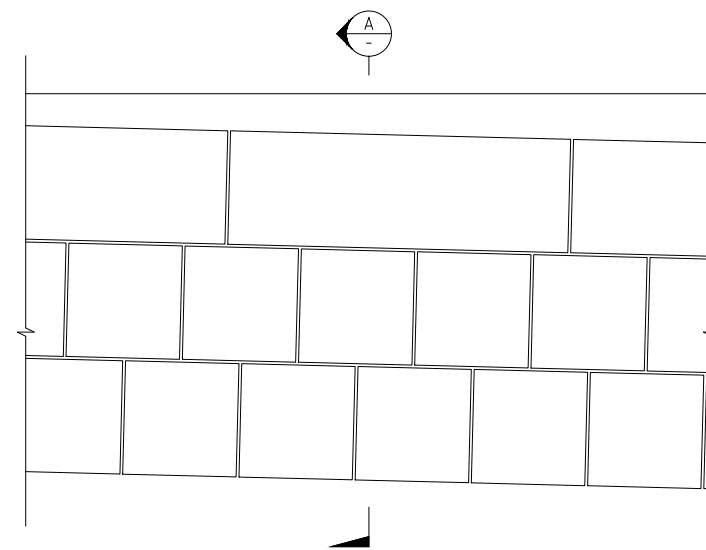

ALTERNATE PRE-CAST OPTION
1:20

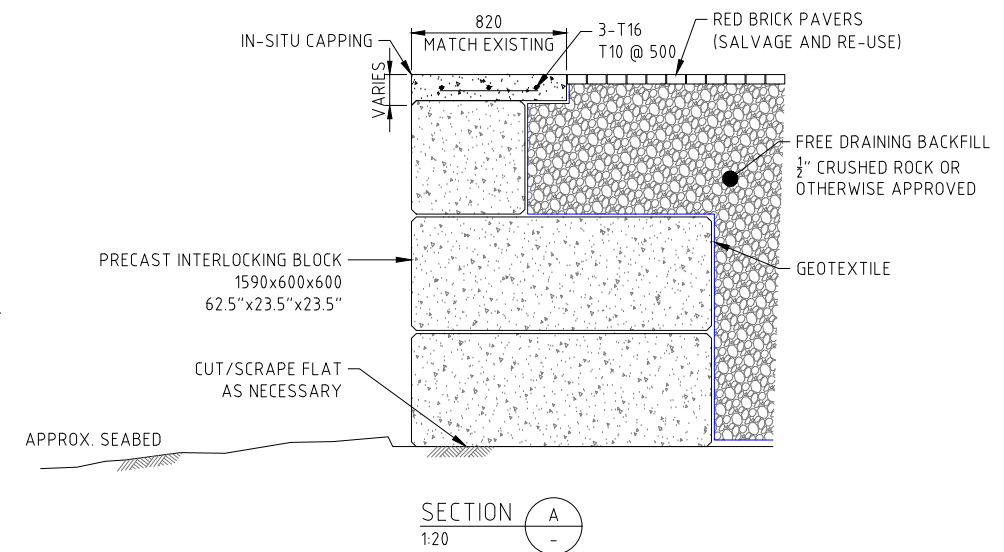

LARGE BLOCK 1785x800x800 APPROX. 2.7 TONNE
SMALL BLOCKS 1590x600x600 APPROX. 1.4 TONNE

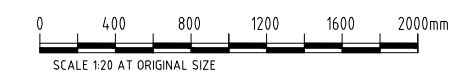

ISSUED FOR: INFORMATION		
AMENDMENTS:		
NO:	REVISION	DATE:
A	FOR CONSTRUCTION	26/04/24

SCALE: AS SHOWN AT ANSI D		
SURVEY		
PREPARED: -	DATE: -	
DESIGN		
PREPARED: -	DATE: -	
CHECKED: -	DATE: -	
DRAWING		
PREPARED: A.KENNY	DATE: XX/XX/2024	
CHECKED: -	DATE: -	
APPROVED BY: A.KENNY		
PROJECT NUMBER: XX-XX-XX		

PROJECT NAME:	
WHITE'S ISLAND DOCK REMEDIATION	
WHITE'S ISLAND, PAGET	
SHEET TITLE: ALTERNATIVE PRE-CAST CONCRETE UNITS	
SHEET NUMBER: S004	REVISION A